

TAX COMMISSION BUILDING
COMPUTER ROOM AIR
CONDITIONING REPLACEMENT
DFCM# 06172310

DFCM DESIGN AND CODE CRITERIA

(Fee A.E: Attach and fill in applicable data for each drawing submittal)

Applicable Codes:
International Building Code
Planning & Design Criteria to Prevent
Architectural Barriers for the Aged and
the Physically Handicapped.

Year
2003

International Mechanical Code
International Plumbing Code
Ashrae/IES Energy Code
National Electrical Code

Year
2003
2003
90.1-1999-2003
2002

A. Occupancy and Group : B / S-1

EXISTING

Change in Use : Yes No ☒ Mixed Occupancy : Yes No

B. Type of Construction (Circle)

I F.R. II F.R. III 1 HR. IV B 1 HR. V N H.T. VI 1 HR. VII N

C. Location on Property : F.R. Ext. Walls (Hrs.):

N.R. Ext. Wall Opening(s) Protection (Hrs.)

N.R.

D. Occupancy separation required (Hrs.):

EXISTING

Sprinklered: Indicate Yes or No

Stories : 1 or multiple

a. Actual Area²(ft)

EXISTING N.A.

b. Basic allowable area :

% Area (ft²)

% Area (ft²)

% Area (ft²)

c. Allowable Area Increase
due to side yards: N.A.

d. Side yard area increase (ft)

N.A.

Accumulative sub-total (b+d):

N.A.

Sprinkler: area increase (x3 single)

N.A.

(x 2 multi)

N.A.

e. Total Allowable Area for a single
story:

N.A.

x 2 for multi-story building:

N.A.

f. Ratio = a/e

N.A.

(Actual divided by allowable)

E. Fire-Resistive Requirements (Hrs.): (1 Hr., 2Hr., 3Hr., 4Hr., N. H.T.)

Exterior Bearing Walls: N

Floors - Ceiling Floors: N/A

Interior Bearing Walls: N

Roofs - Ceiling Roofs: N

Exterior Non-bearing Walls: N

Exterior Doors and Windows: NR

Structural Frame: N

Shaft Enclosures: NR

Partitions - Permanent: N

(OCCUPANCY SEPARATION - N.A.)



State of Utah—Department of Administrative Services

DIVISION OF FACILITIES CONSTRUCTION
AND MANAGEMENT

4110 State Office Building / Salt Lake City, Utah 84114 / 538-3018

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ELECTRICAL ENGINEER

BNA CONSULTING ENGINEERS
635 SOUTH STATE ST.
SALT LAKE CITY, UTAH 84111

SLC. (801) 532-2196; FAX: (801) 532-2305

DRAWING INDEX:

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EP101	ELECTRICAL POWER PLAN LEVEL 1
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EX101	ELECTRICAL DETAILS



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**TAX COMMISSION
BLDG. COMP ROOM
AC REPLACEMENT**

210 North 1950 West
Salt Lake City, Utah

00020
SHEET TITLE

SHEET NO. _____

MG001

MC	MECHANICAL CONTRACTOR
CC	CONTROL CONTRACTOR
EC	ELECTRICAL CONTRACTOR
FPC	FIRE PROTECTION CONTRACTOR
NIC	NOT IN CONTRACT
NTS	NOT TO SCALE
VCP	VITRIFIED CLAY PIPE
C	COMMON
NC	NORMALLY CLOSED
NO	NORMALLY OPEN

RF	RELIEF AIR
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G-1

A - EACH DRAWING SHEET AND THE SPECIFICATIONS HAVE BEEN PREPARED TO SUPPLEMENT EACH OTHER AND THEY SHALL BE INTERPRETED AS AN INTEGRAL UNIT WITH ITEMS SHOWN AND NOTED ON ONE AND NOT THE OTHER BEING FURNISHED AND INSTALLED AS THOUGH SHOWN AND CALLED OUT IN ALL PLACES. ITEMS IN SPECIFICATIONS OR DRAWINGS LISTED WHICH ARE DIFFERING IN EFFICIENCY OR QUALITY SHALL BE HELD TO THE GREATEST OF: EFFICIENCY, QUALITY OR GOVERNING CODE.

C - THE CONTRACTOR SHALL INSTALL ALL EQUIPMENT WITH PROPER SERVICE ACCESS AND CLEARANCES ACCORDING TO MANUFACTURERS RECOMMENDATIONS. THE CONTRACTOR SHALL REVIEW SUPPLIERS BID PACKAGES FOR COMPLETENESS AND COMPLIANCE TO THE SPECIFICATIONS, SCHEDULES, AND DESIGN INTENT (ALL EQUIPMENT AND METHODS). THE CONTRACTOR SHALL REMOVE AND REINSTALL CORRECTLY AT HIS OWN EXPENSE ANY EQUIPMENT NOT IN COMPLIANCE.

E - ANYTHING NOT CLEAR OR IN CONFLICT WILL BE EXPLAINED BY MAKING APPLICATION TO THE ENGINEER IN WRITING.

ANY AND ALL ALTERATIONS TO THE SYSTEM SHOWN SHALL BE THE RESPONSIBILITY OF THIS CONTRACTOR. ARCHITECT SHALL BE NOTIFIED IN WRITING PRIOR TO CHANGES.

G-2

G-3

G-4

G-5

G-6


G-7

G-8

G-9



G-10

G-11

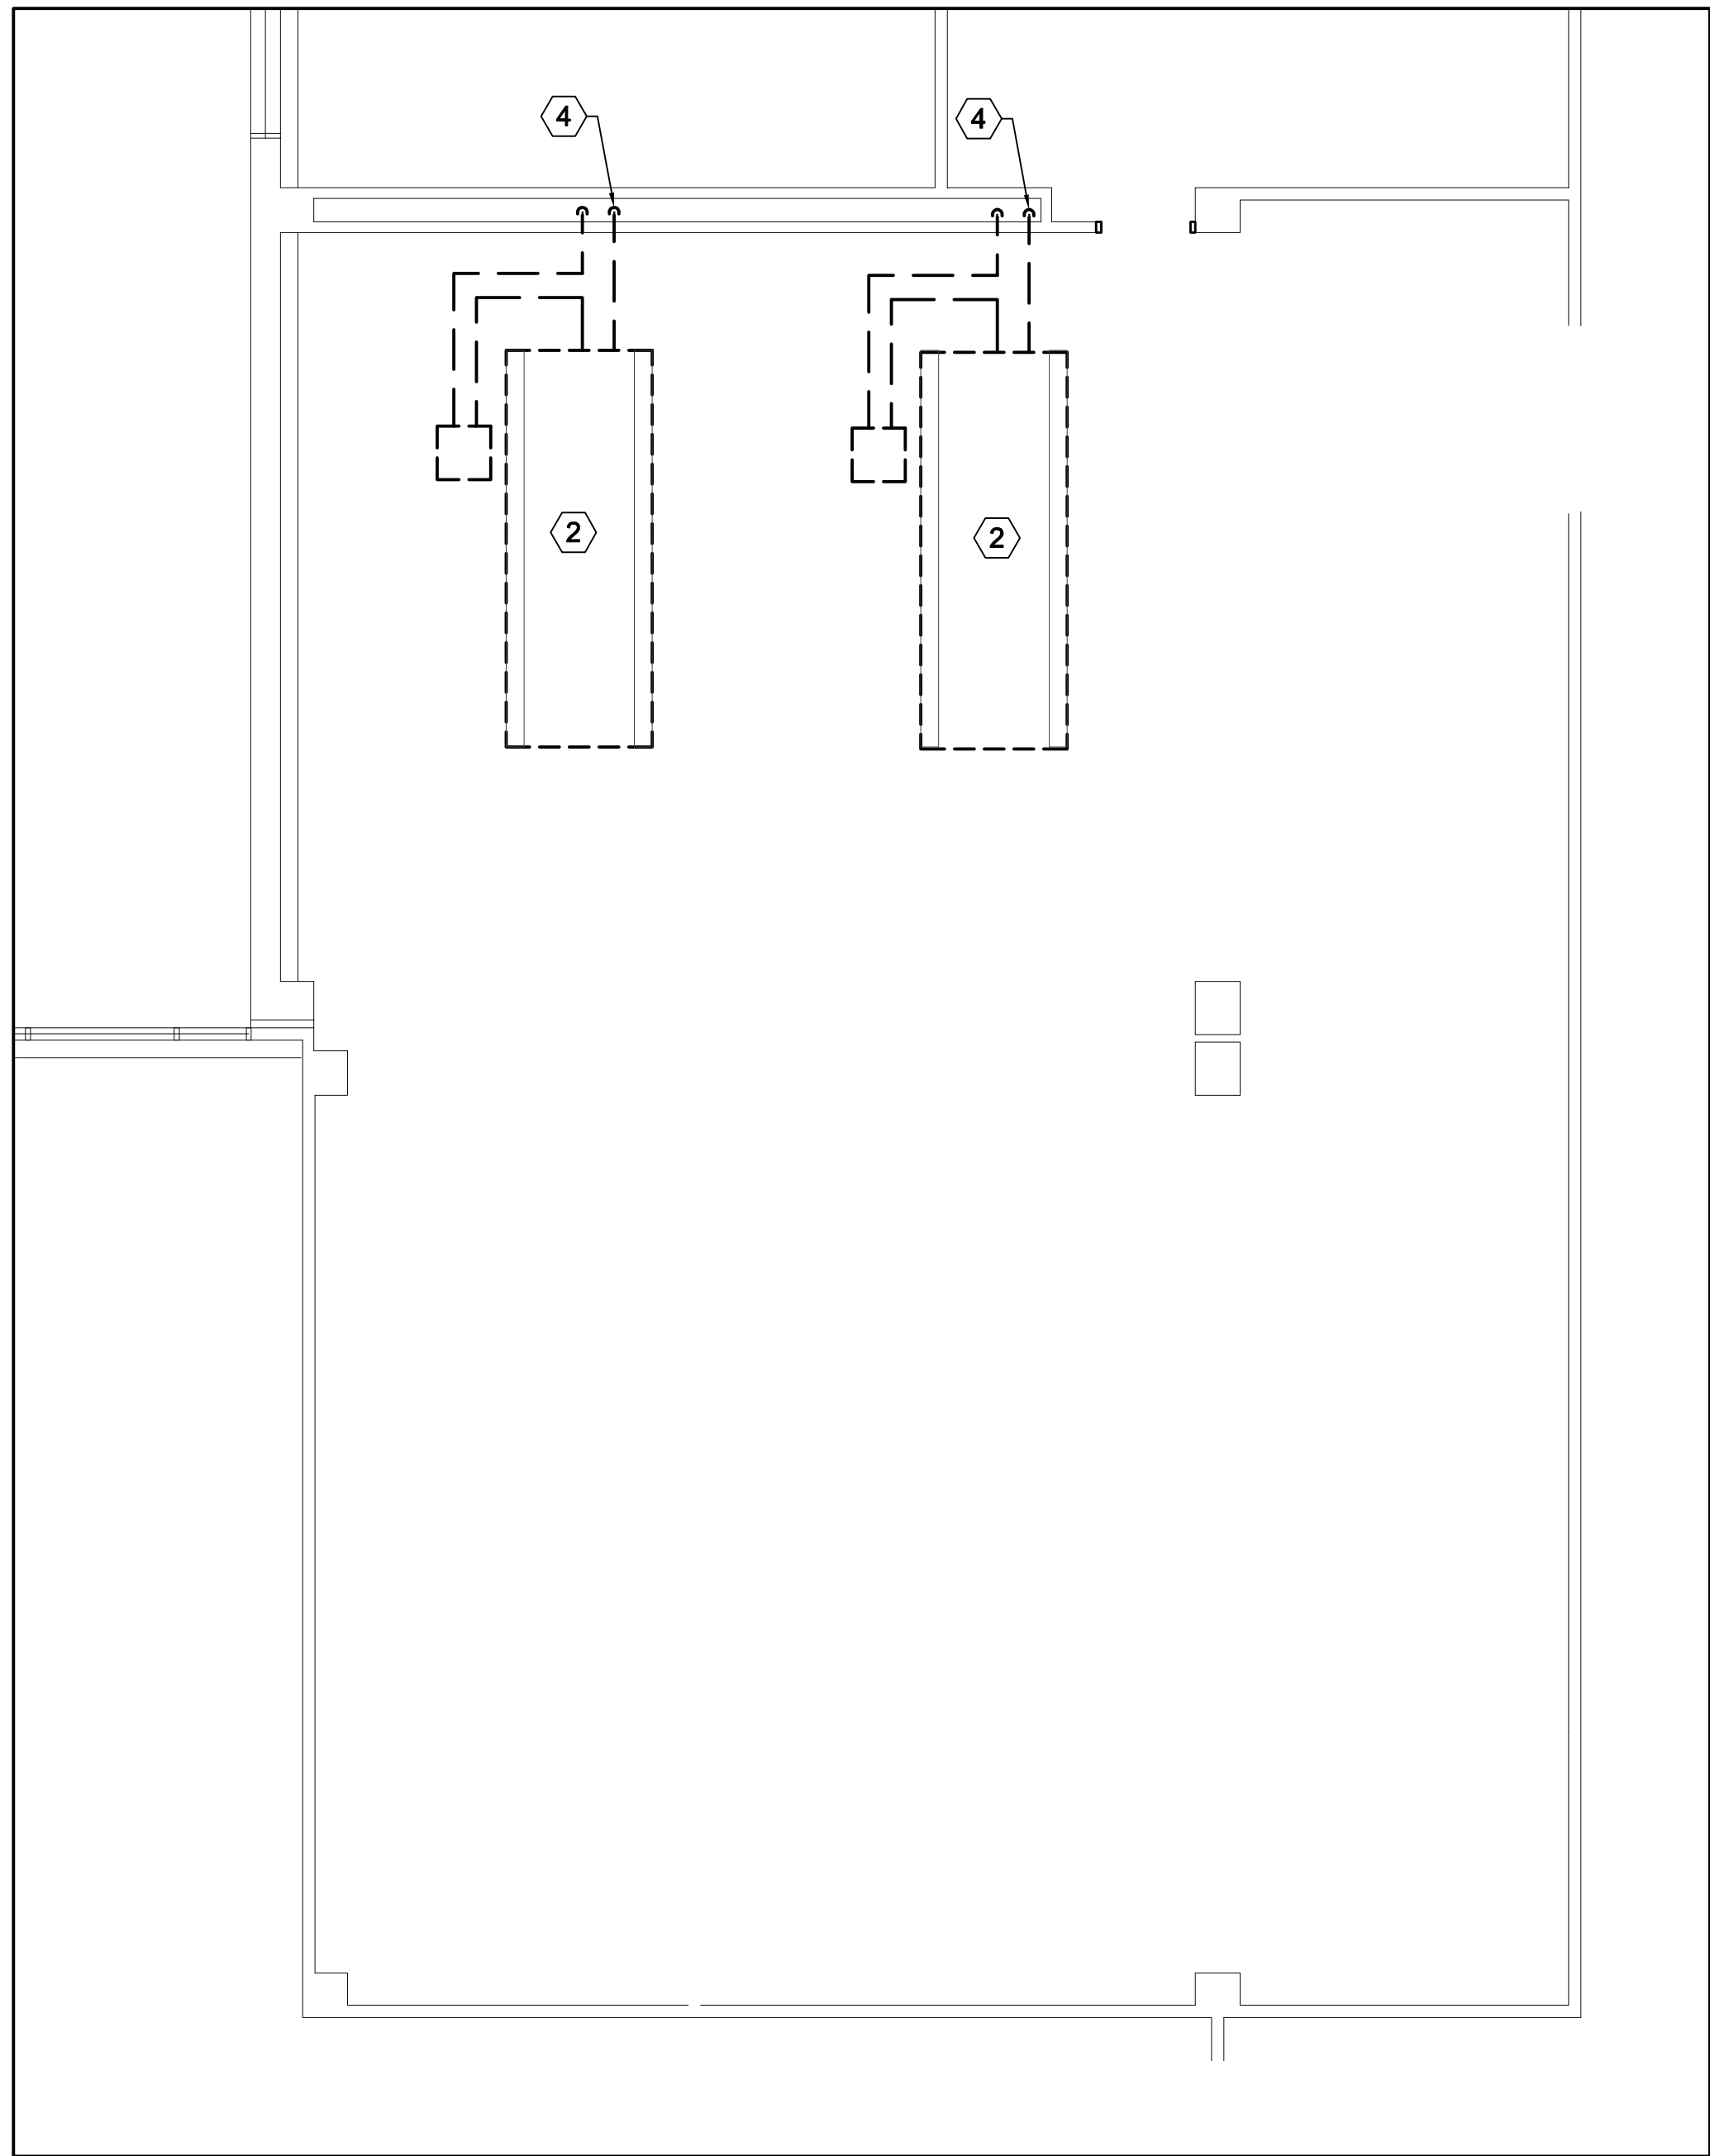


MECHANICAL ROOF DEMOLITION PLAN

SCALE: 3/16" = 1'-0"

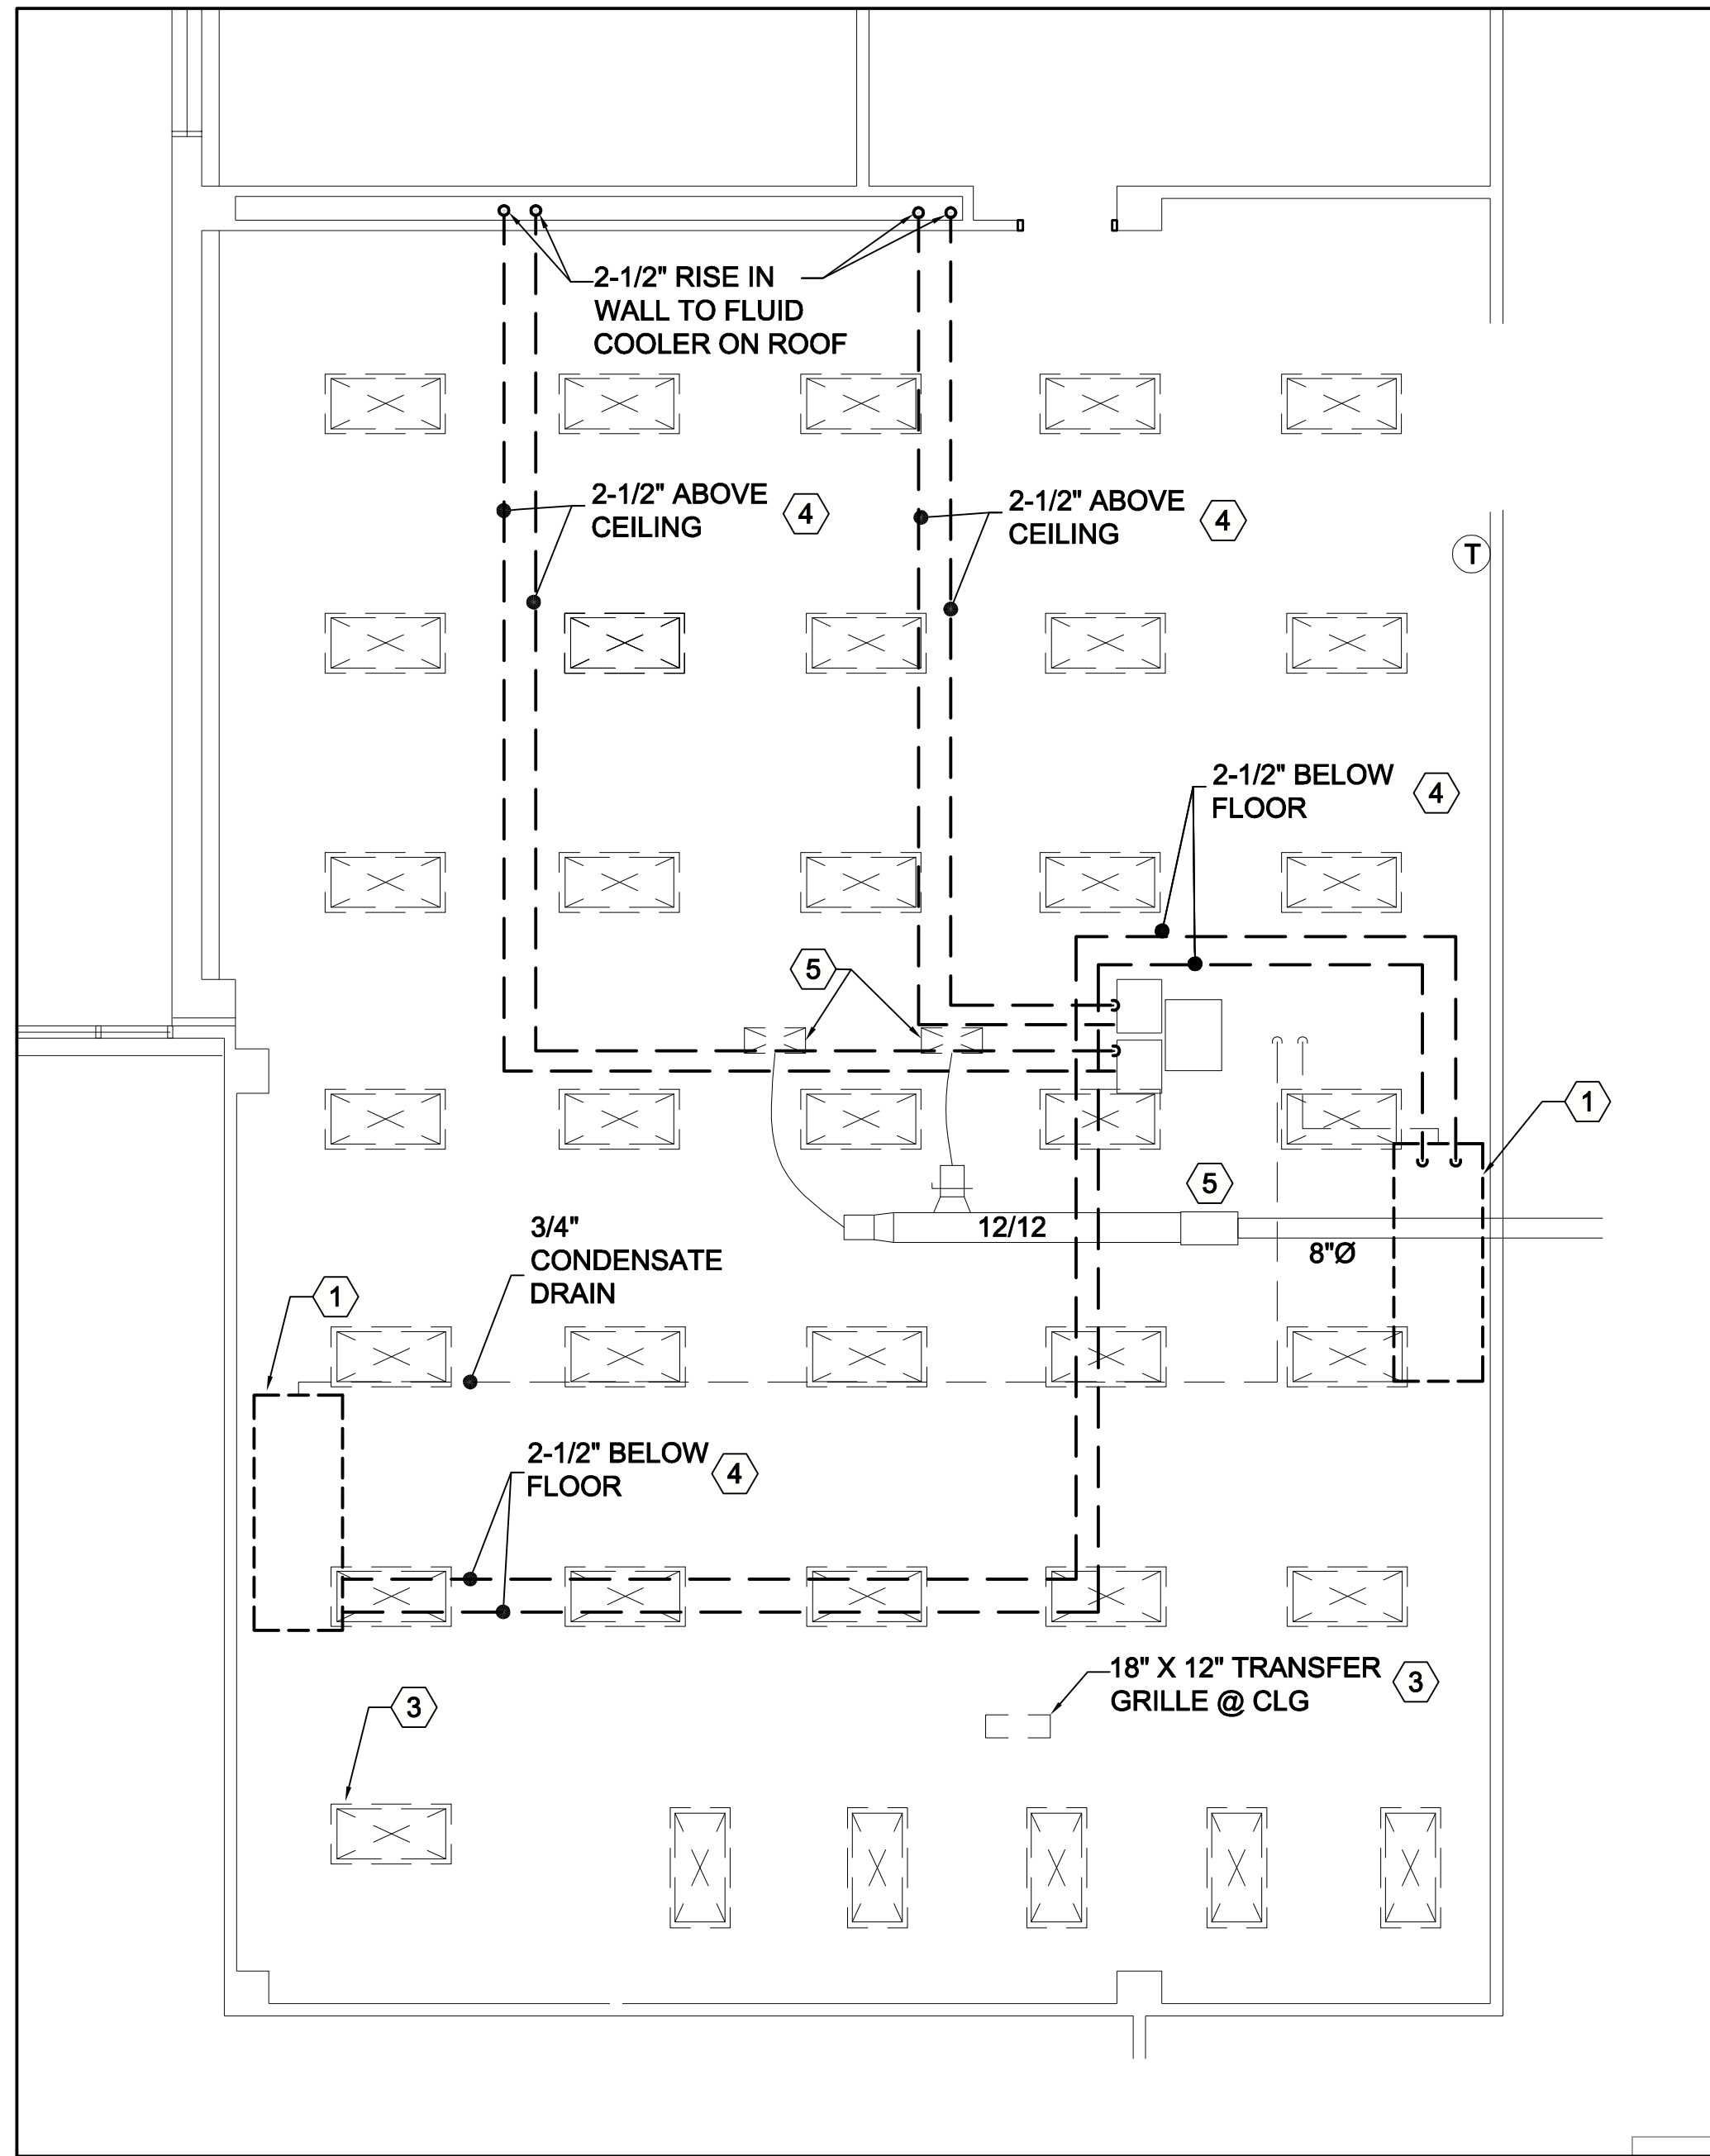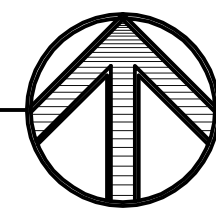

MECHANICAL DEMOLITION PLAN

SCALE: 3/16" = 1'-0"

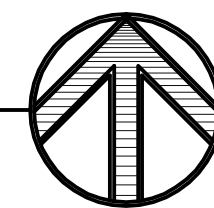


SHEET NOTES

- 1 REMOVE EXISTING COMPUTER ROOM COOLING UNIT.
- 2 REMOVE EXISTING FLUID COOLER AND ASSOCIATED PUMP, EXPANSION TANK, ETC. THIS CONTRACTOR SHALL HIRE A ROOFING CONTRACTOR TO REMOVE ROOF CURB RAILS, AND PATCH AND SEAL ROOF. COORDINATE WITH ME102.
- 3 EXISTING FLOOR SUPPLY DIFFUSERS SHALL REMAIN.
- 4 REMOVE EXISTING GLYCOL PIPING. THIS CONTRACTOR SHALL HIRE AN APPROVED ROFFING CONTRACTOR TO PATCH AND SEAL ABANDONED ROOF PENETRATION.
- 5 EXISTING VAV BOX AND ASSOCIATED DUCT AND DIFFUSERS SHALL REMAIN.


GENERAL NOTE:

COORDINATE DEMOLITION SCHEDULE WITH OWNER, USER, AND DIVISION 16. UNITS SHALL BE REPLACED ONE AT A TIME SO COOLING FROM AT LEAST ONE UNIT WILL ALWAYS BE AVAILABLE TO ROOM.

KEY PLAN

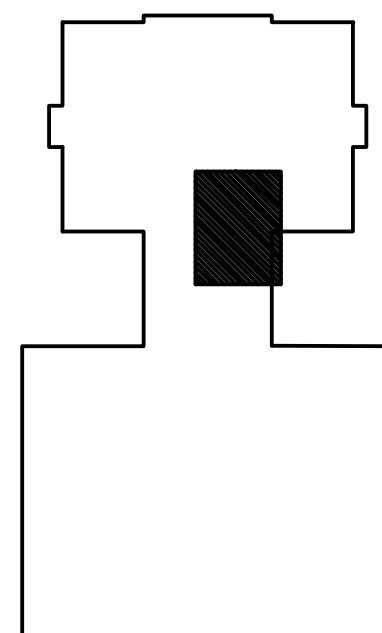

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Department of Administrative Services

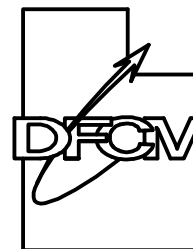

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STAFF

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DATE:

09/28/06

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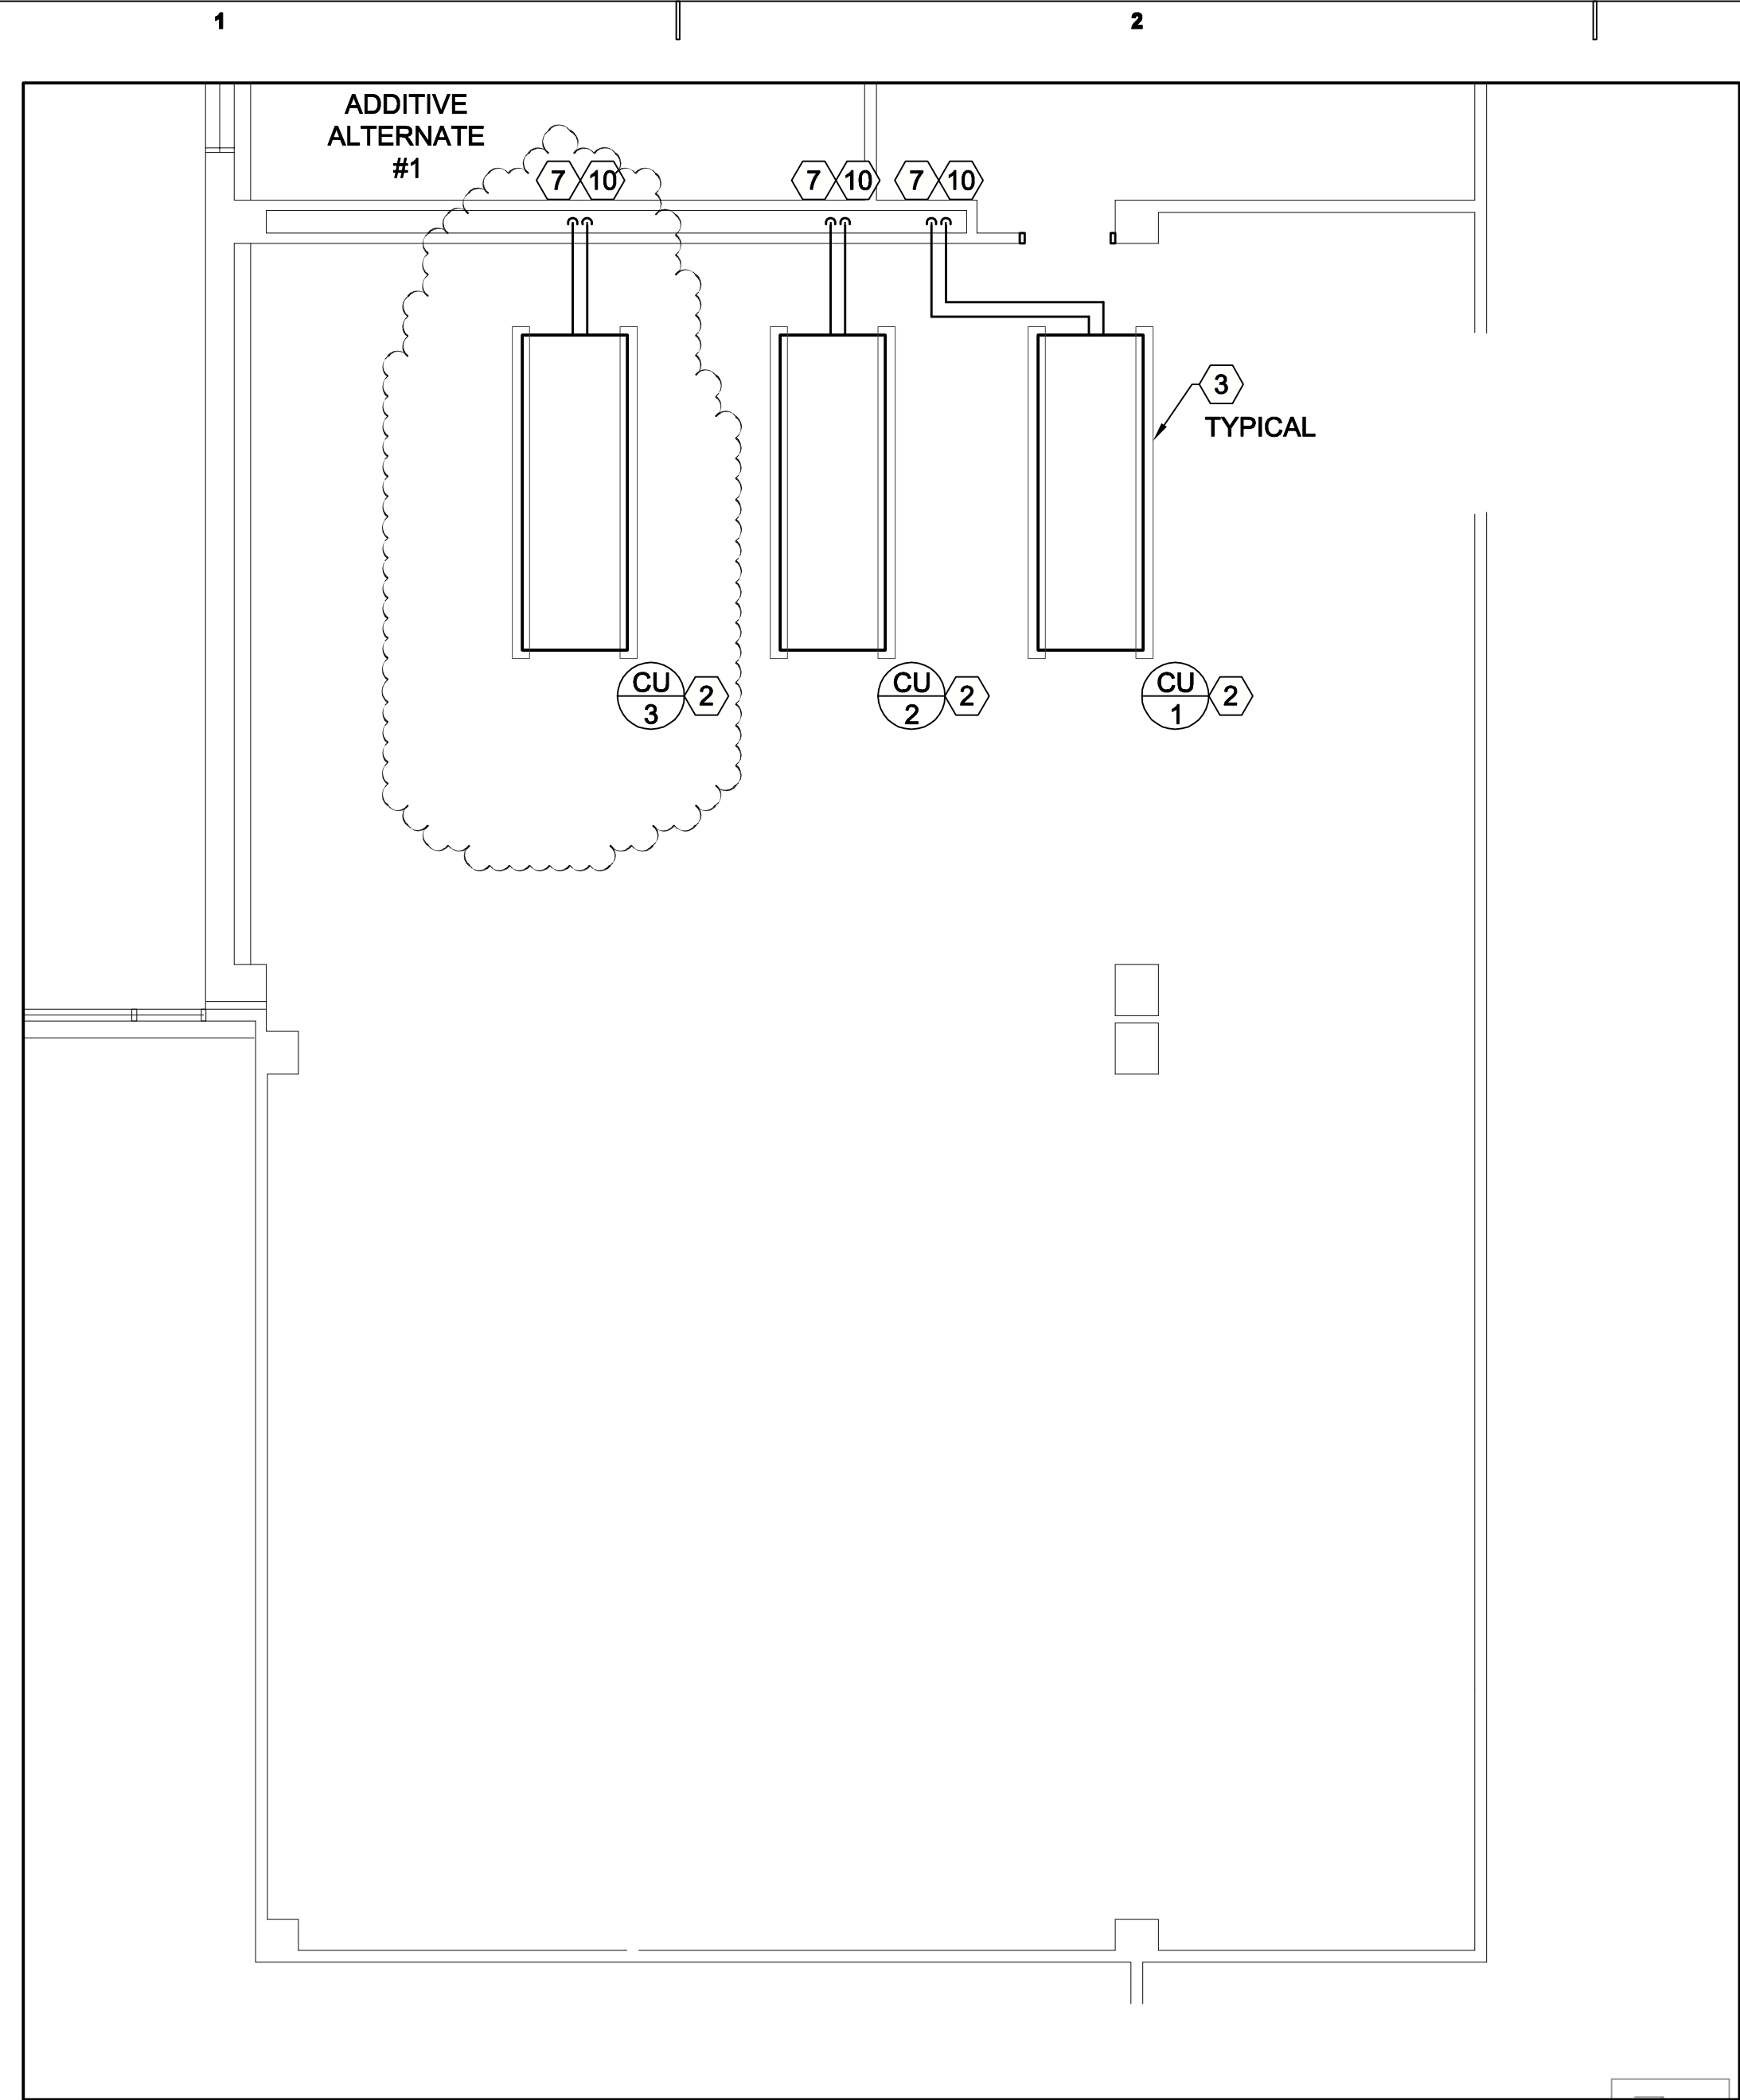
06020

SHEET TITLE

**MECHANICAL
DEMOLITION PLANS**



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MD101




NEW MECHANICAL ROOF PLAN

SCALE: 3/16" = 1'-0"

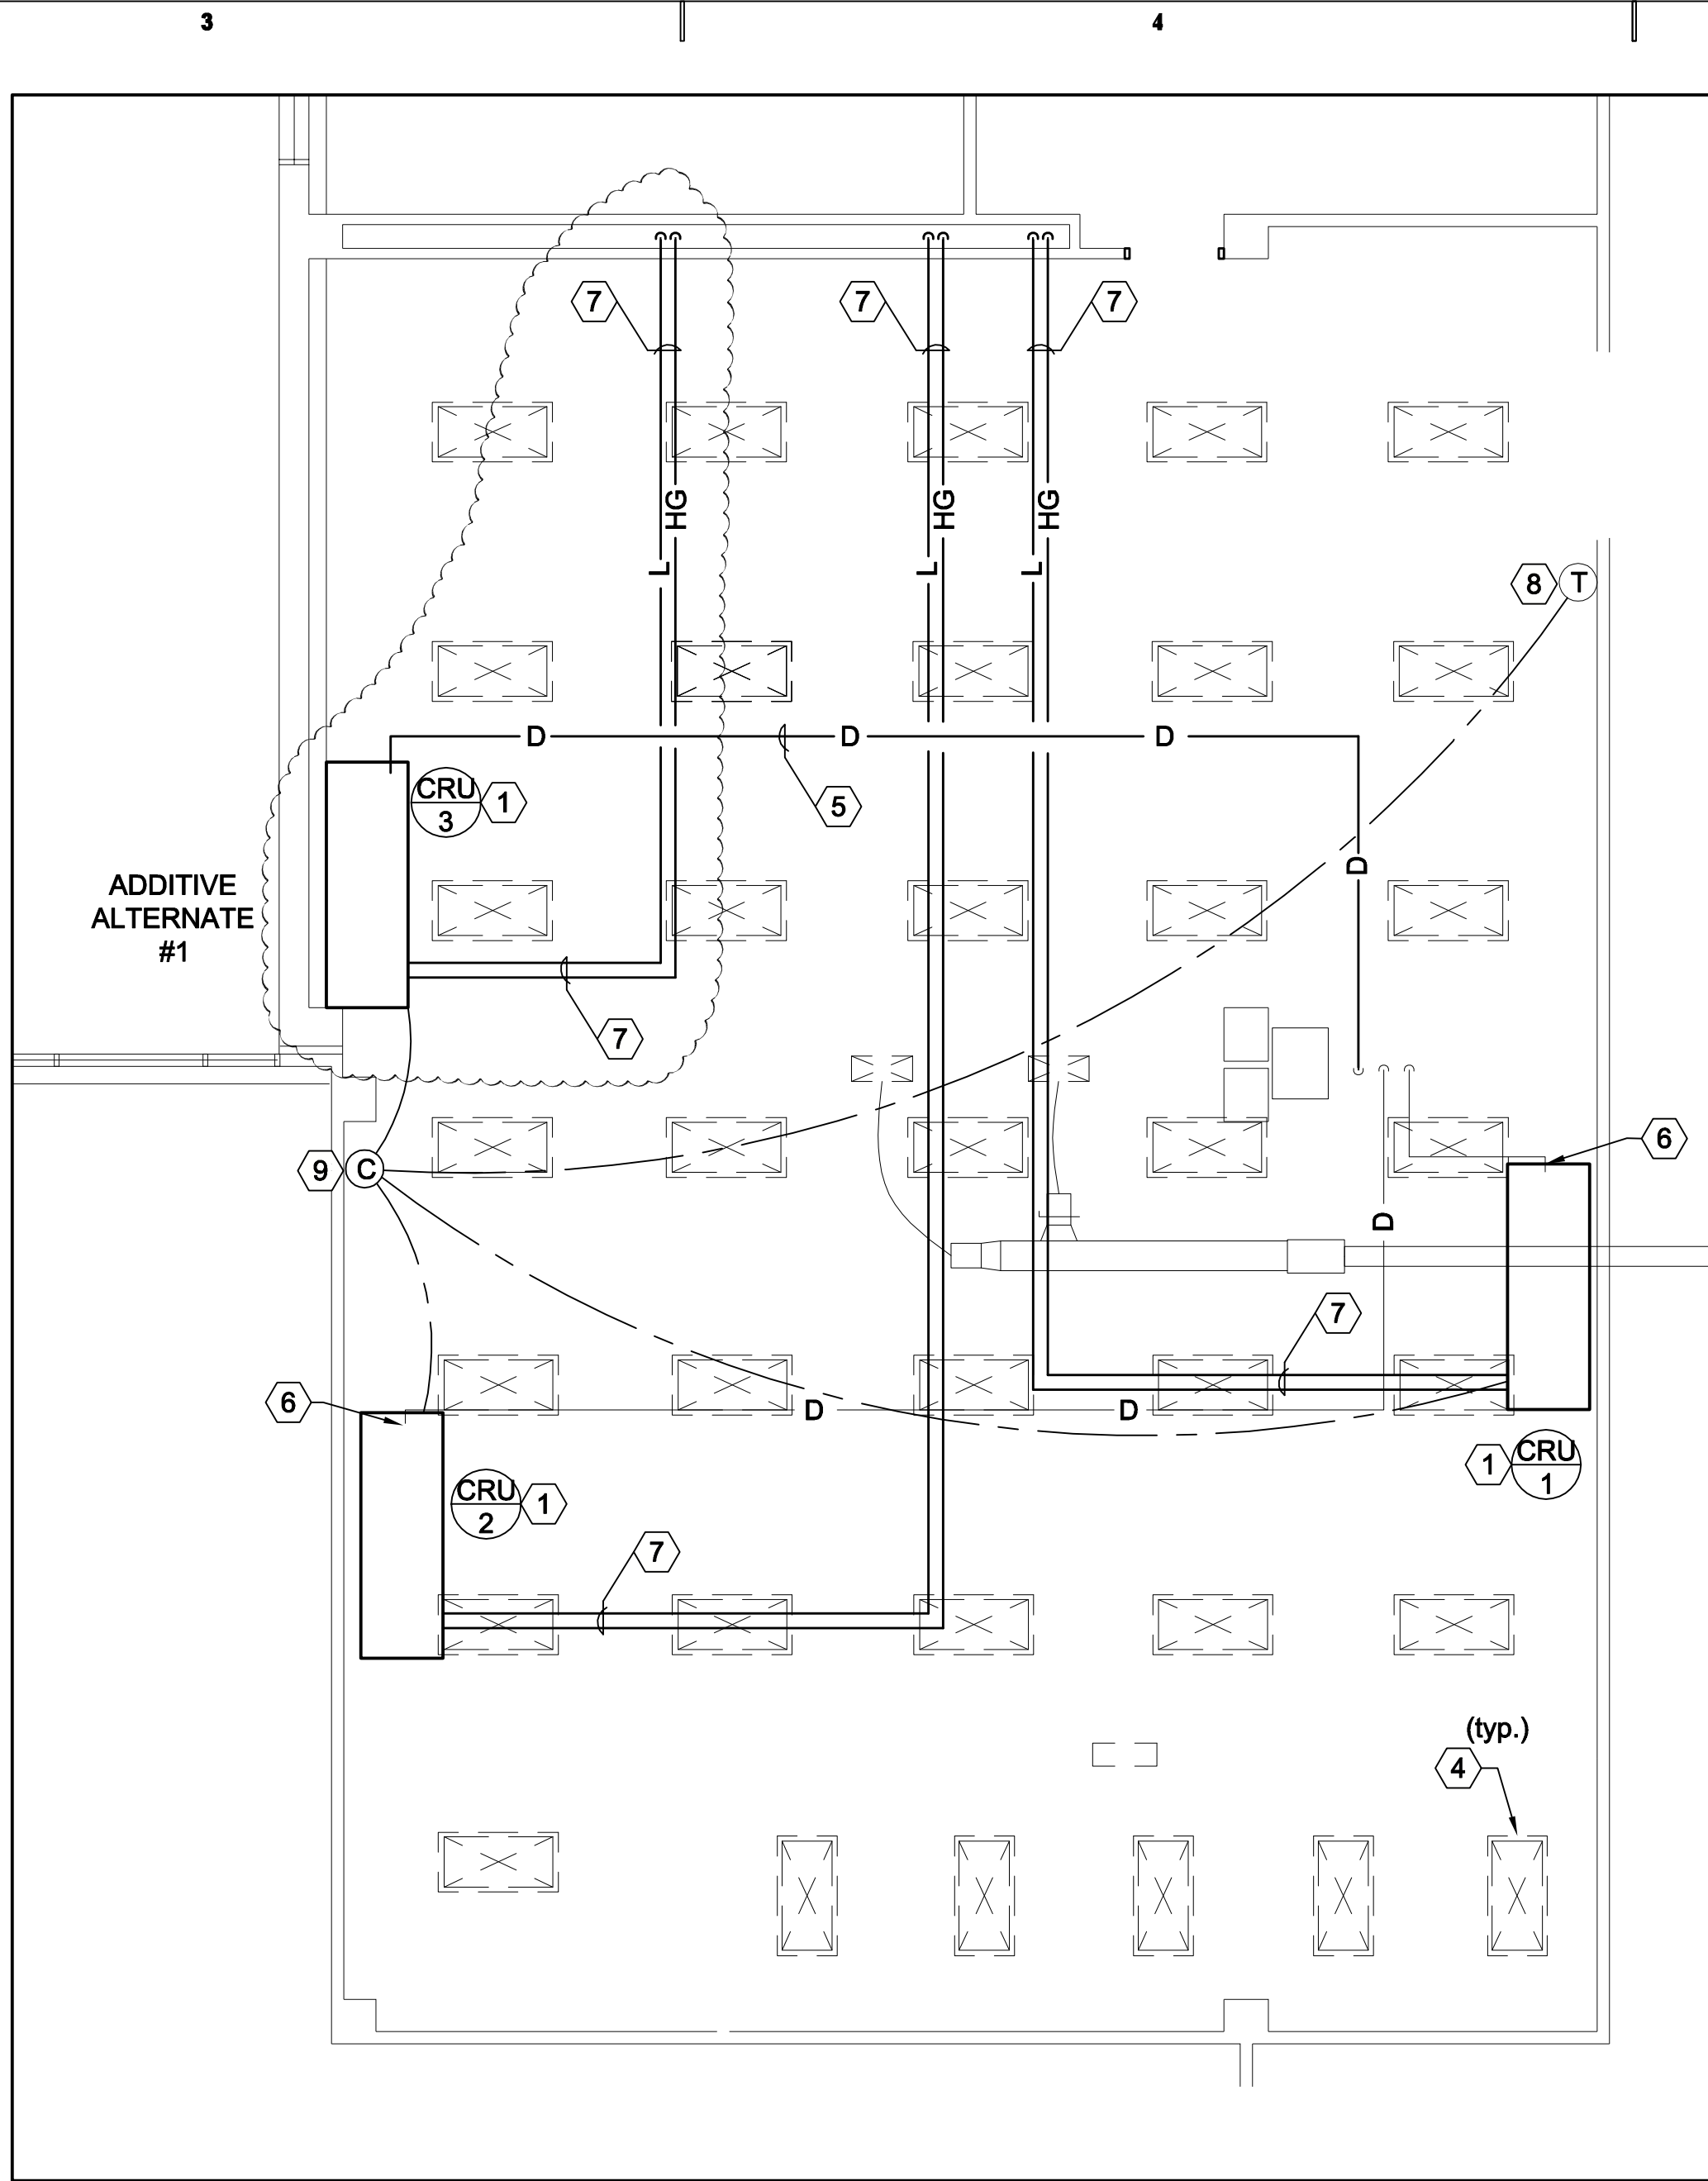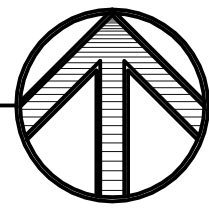

NEW MECHANICAL PLAN

SCALE: 3/16" = 1'-0"

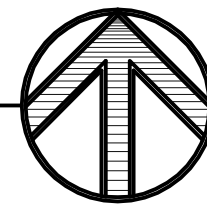


SHEET NOTES

- 1 PROVIDE NEW COMPUTER ROOM COOLING UNIT, COMPLETE WITH NEW FLOOR STAND, DOWN FLOW TURNING VANE, ETC.
- 2 PROVIDE NEW CONDENSING UNITS ON ROOF. PIPE PER DETAILS. THIS CONTRACTOR SHALL HIRE AN APPROVED ROOFING CONTRACTOR TO INSTALL NEW ROOF RAILS FOR EQUIPMENT SUPPORT.
- 3 PROVIDE NEW ROOF MOUNTED SUPPORT RAILS TO MATCH EXISTING. COORDINATION WITH ROOFING CONTRACTOR TO FLASH, CAP, AND SEAL NEW ROOF RAILS. FIELD VERIFY EXACT SIZE AND LOCATION OF NEW SUPPORT RAILS.
- 4 EXISTING FLOOR SUPPLY DIFFUSERS SHALL REMAIN.
- 5 PROVIDE NEW CONDENSATE DRAIN FROM NEW CRU-3 TO EXISTING FLOOR DRAIN.
- 6 RE-CONNECT EXISTING CONDENSATE DRAIN PIPING TO NEW COOLING UNIT.
- 7 PROVIDE NEW 1-1/8" HOT GAS AND NEW 7/8" LIQUID PIPING FROM INDOOR UNITS TO OUTDOOR UNITS. EACH UNIT SHALL HAVE 2 SETS OF PIPING, ONE FOR EACH CIRCUIT. PIPE PER DETAILS AND MANUFACTURERS RECOMMENDATIONS.
- 8 PROVIDE NEW THERMOSTAT.
- 9 PROVIDE NEW CONTROLLER TO RUN ALL UNITS. 2 UNITS SHALL RUN CONTINUOUSLY, WITH THE 3RD AS A BACKUP UNIT SHALL ALTERNATE FOR EQUAL RUN TIME.
- 10 PROVIDE NEW PIPING RISERS TO ROOF. THIS CONTRACTOR SHALL HIRE A ROOFING CONTRACTOR TO CUT AND SEAL AROUND NEW PIPE PENETRATIONS.


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06020

SHEET TITLE

**NEW MECHANICAL
PLANS**

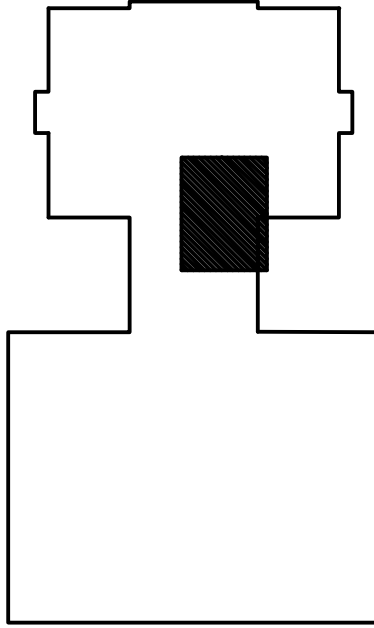SHEET NO.

ME101

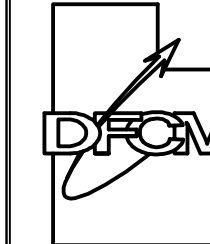

C1 FAN SPEED CONTROL CONDENSERS DETAIL
SCALE: NONE




COMPUTER ROOM INDOOR UNIT SCHEDULE

1. COND. ENTERING EVAPORATOR 75 FDB & 40% RH AT 4200' ELEVATION.
2. DOWNFLOW UNIT WITH FLOOR STAND AND TURNING VANE.
3. PROVIDE WITH SINGLE POINT POWER CONNECTION, AND FACTORY DIS-CONNECT.
4. PROVIDE WITH 4 STEP CONTROL CYLINDER UNLOADERS.
5. PROVIDE A CONTROLLER TO MANAGE ALL THREE UNITS.



COMPUTER ROOM OUTDOOR UNIT SCHEDULE

ADDITIVE
ALTERNATE #1

1. PROVIDE WITH FAN SPEED CONTROL FOR -20 LOW AMBIENT.
2. AT DESIGN CONDITIONS AND 100° ENTERING AIR TEMPERATURE TO CONDENSER.
3. CONDENSING UNIT SYMBOLS CORRESPOND WITH COMPUTER ROOM UNIT SYMBOLS.
4. SEE SPECIFICATIONS FOR APPROVED MANUFACTURES.
5. PROVIDE WITH SINGLE POINT POWER CONNECTION AND FACTORY DISCONNECT.

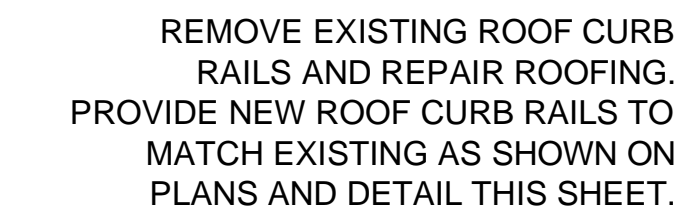


A3 ROOF CURB RAIL DETAIL
SCALE: NONE

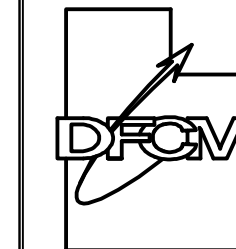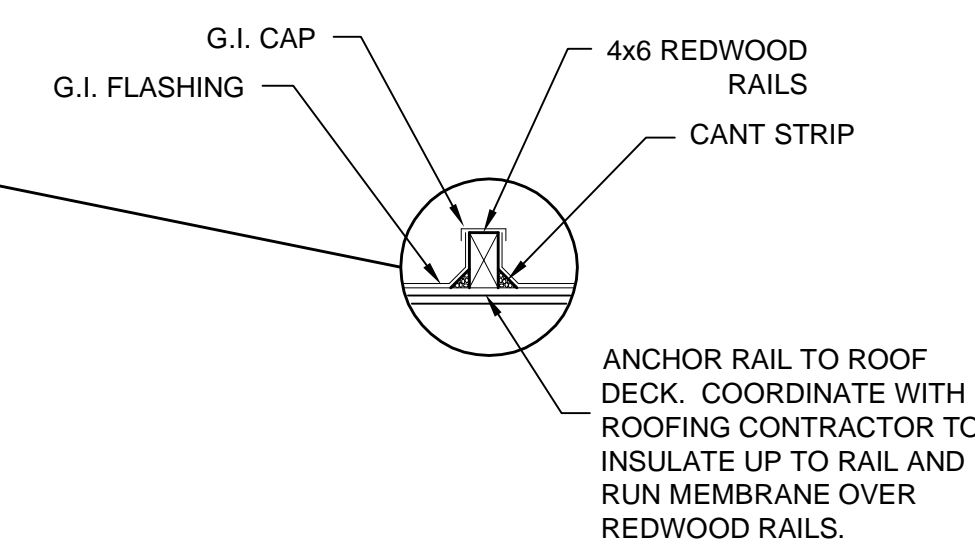

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DFCM No. 06172310

210 North 1950 West
Salt Lake City, Utah

[illegible]

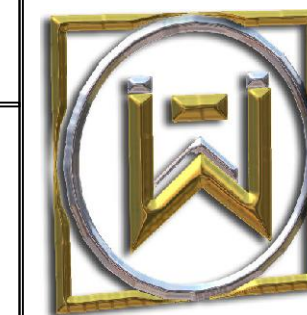PROJECT MANAGER:

WP

DRAWN BY:
STAFF

CHECKED BY:
SLW

DATE: 09/28/06

09/28/06
WHW JOB NO.: 06020

00020
SHEET TITLE

SCHEDULES AND DETAILS

SHEET NO.


ME601

EQUIPMENT SCHEDULE													
UNIT #	FUNCTION	LOAD	VOLT	PHASE	FULL LOAD AMPS	CONDUIT SIZE	NO. SETS	WIRES			OCPD		
								NO.	SIZE	TYPE	AMPS	STARTER	DISCONNECT
CRU-1	COMPUTER ROOM UNIT	46.6 FLA	460	3	46.6	-	-	-	-	-	-	C	C
CRU-2	COMPUTER ROOM UNIT	46.6 FLA	460	3	46.6	-	-	-	-	-	-	C	C
CRU-3	COMPUTER ROOM UNIT	46.6 FLA	460	3	46.6	-	-	-	-	-	-	C	C
CU-1	CONDENSING UNIT	6.4 FLA	460	3	6.4	-	-	-	-	-	-	C	C
CU-2	CONDENSING UNIT	6.4 FLA	460	3	6.4	-	-	-	-	-	-	C	C
CU-3	CONDENSING UNIT	6.4 FLA	460	3	6.4	-	-	-	-	-	-	C	C
NOTES: 1. NON-FUSED DISCONNECT SWITCH 2. FUSED DISCONNECT SWITCH 3. BREAKER IN ENCLOSURE 4. MANUAL STARTER W/THERMAL OVERLOAD 5. MAGNETIC STARTER 6. MAGNETIC STARTER/NON-FUSED DISCONNECT COMBINATION 7. MAGNETIC STARTER/FUSED DISCONNECT COMBINATION 8. MAGNETIC STARTER/BREAKER COMBINATION 9. VARIABLE FREQUENCY DRIVE 10. REDUCED VOLTAGE STARTER 11. DIRECT CONNECTION 12. RECEPTACLE/SPECIAL PURPOSE OUTLET/ETC. 13. TWO-SPEED STARTER, COORDINATE W/MOTOR TYPE													
A. FURNISHED, INSTALLED, AND CONNECTED UNDER DIVISION 16 B. FURNISHED AND INSTALLED UNDER ANOTHER DIVISION REQUIRING CONNECTION UNDER DIVISION 16. C. FURNISHED UNDER ANOTHER DIVISION BUT INSTALLED AND CONNECTED UNDER DIVISION 16. D. FURNISHED, INSTALLED AND CONNECTED UNDER ANOTHER DIVISION. OVER CURRENT PROTECTIVE DEVICES CB = CIRCUIT BREAKER - THERMAL MAGNETIC FN = FUSE - NON INDUCTIVE LOAD FI = FUSE - INDUCTIVE LOAD MO = MAGNETIC ONLY CIRCUIT BREAKER													

GENERAL NOTES													
1. CONSULT ARCHITECTURAL REFLECTED CEILING PLANS FOR EXACT LOCATION OF ALL LIGHTING FIXTURES.													
2. VERIFY ALL EQUIPMENT DIMENSIONS AND LOCATIONS BEFORE BEGINNING ROUGH IN. CONSULT ALL APPLICABLE CONTRACT DRAWINGS AND SHOP DRAWINGS TO INSURE NEC CODE CLEARANCES REQUIRED AROUND ALL ELECTRICAL EQUIPMENT.													
3. CONTRACTOR SHALL VERIFY ALL ELECTRICAL LOADS (VOLTAGE, PHASE, CONNECTION REQUIREMENTS, ETC.) OF EQUIPMENT FURNISHED UNDER DIVISION 15 WITH APPROVED MECHANICAL SHOP DRAWINGS BEFORE BEGINNING ROUGH IN.													
4. SEE APPLICABLE SHOP DRAWINGS FOR ROUGH IN LOCATION OF ALL EQUIPMENT, WIRING DEVICES, ETC. WHERE APPLICABLE MOUNT ALL WIRING DEVICES ABOVE BACK SPLASH EXCEPT THOSE SERVING UNDER COUNTER EQUIPMENT.													
5. SEE SPECIFICATION FOR ENERGY SAVING LAMP AND BALLAST REQUIREMENTS.													
6. FINISHES OF ALL LIGHT FIXTURES SHALL BE AS SELECTED BY ARCHITECT.													
7. THE ELECTRICAL CONTRACTOR SHALL NOTIFY AND COOPERATE WITH THE MECHANICAL CONTRACTOR SUCH THAT NO PIPING, DUCTS, OR EQUIPMENT FOREIGN TO THE OPERATION OF THE ELECTRICAL EQUIPMENT SHALL BE PERMITTED TO BE INSTALLED IN, ENTER OR PASS THRU ELECTRICAL ROOMS OR SPACES, OR ABOVE OR BELOW ELECTRICAL EQUIPMENT IN OTHER AREAS.													
ELECTRICAL BOXES SHALL NOT BE LOCATED IN MASONRY COLUMNS IN BRICK WALLS OR IN GROUTED CELLS ADJACENT TO OPENINGS. COORDINATE LOCATION OF BOXES WITH MASONRY CONTRACTOR.													
9. ALL PENETRATIONS OF FIRE RATED FLOORS, WALLS, AND CEILINGS SHALL BE SEALED WITH APPROVED MATERIAL TO MAINTAIN FIRE RATING OF SURFACE PENETRATED.													
10. CIRCUITS EXTENDING OVER 70' FOR 120 VOLT AND 165' FOR 277 VOLT 20 AMP CIRCUITS SHALL BE RUN WITH MINIMUM #10 CONDUCTORS.													

DEMOLITION NOTES													
1. COORDINATE ALL NEW ELECTRICAL EQUIPMENT REQUIREMENTS AND MAKE CONNECTION TO EXISTING SYSTEMS. THIS INCLUDES LIGHTING, POWER, SIGNAL, RACEWAY AND OTHER SYSTEMS INCLUDED UNDER DIVISION 16.													
2. RELOCATE, REWIRE AND/OR RECONNECT EXISTING ELECTRICAL DEVICES AND/OR EQUIPMENT THAT FOR ANY REASON OBSTRUCTS CONSTRUCTION.													
3. CONCEAL ALL RACEWAY AND WIRING IN EXISTING WALLS, CEILINGS, FLOORS, ETC. EXCEPT WHERE THE USE OF SURFACE METAL RACEWAYS (E.G. WIRE MOLD) IS INDICATED ON DRAWINGS OR IN SPEC.													
4. LEAVE ALL EXISTING EQUIPMENT, IN PORTIONS OF THE BUILDING NOT BEING REMODELED, IN WORKING CONDITION. RESTORE ALL INTERRUPTED BRANCH CIRCUITS, FEEDERS, ETC. TO WORKING CONDITION.													
5. EXISTING RACEWAYS MAY BE REUSED (IN PLACE) WHERE POSSIBLE, AND WHERE IN COMPLIANCE WITH THE SPECIFICATIONS AND THE INTENT OF THE CONTRACT DOCUMENTS. INSURE INTEGRITY OF EXISTING RACEWAY BEFORE REUSE.													
6. REMOVE ALL RACEWAYS, CONDUCTORS, BOXES, DEVICES, EQUIPMENT, ETC. THAT ARE NOT TO BE REUSED.													
7. REMOVE EXISTING LIGHT FIXTURES WHICH ARE NOT TO BE REUSED, PLACE IN CARTON, LABEL APPROPRIATELY, AND RETURN TO OWNER, OR PROPERLY DISPOSE OF FIXTURES THAT THE OWNER CHOOSES NOT TO KEEP.													
8. DO NOT PENETRATE STRUCTURAL ELEMENTS OF FLOORS, WALLS, CEILINGS, ROOFS, ETC.													
9. DISCONNECT AND RECONNECT ANY/ALL FIXTURES, DEVICES, EQUIPMENT, ETC. REQUIRED FOR PROPER COMPLETION OF THE WORK.													


ELECTRICAL SYMBOL SCHEDULE							
1. SEE FIXTURE SCHEDULE FOR TYPE, MOUNTING AND WATTAGE. 2. HEIGHT MEASURED TO CENTER LINE OF THE BOX FROM THE FINISH FLOOR. 3. REFER TO DRAWINGS FOR DIRECTIONAL ARROWS. 4. SUBSCRIPT KEYS SWITCH TO FIXTURES CONTROLLED. 5. NEMA TYPE 'ND' NON-FUSED UNLESS NOTED 'F' (FUSED). USE 'HD' 480 V. 6. HEIGHT TO BE THE LOWER OF EITHER 80" A.F.F. OR 6" BELOW CEILING. 7. PROVIDE H.O.A. AND S.S. PUSHBUTTONS AS REQUIRED.				8. DOUBLE ARROWS DENOTE A DOUBLE FACE UNIT. 9. COORDINATE WITH MILLWORK SHOP DRAWINGS AND ELEVATIONS FOR HEIGHT. 10. SUBSCRIPT DENOTES NEMA CONFIGURATION. 11. HEIGHT MEASURED TO BOTTOM OF THE BOX FROM FINISH FLOOR. * TYPICAL SYMBOL SCHEDULE. SOME SYMBOLS MAY NOT BE USED IN THIS SET OF DRAWINGS.			
STANDARD MOUNTING HEIGHT UNLESS OTHERWISE NOTED ON PLANS				STANDARD MOUNTING HEIGHT UNLESS OTHERWISE NOTED ON PLANS			
SYMBOL	DESCRIPTION	MOUNTING HEIGHT	NOTES	SYMBOL	DESCRIPTION	MOUNTING HEIGHT	NOTES
	ONE CIRCUIT, TWO WIRE HOME RUN TO PANEL				JUNCTION BOX ('F' IN FLOOR)	AS NOTED	
	2 CIRCUIT, 3 WIRE, COMMON NEUTRAL HOME RUN				MOTOR OUTLET	TO SUIT EQUIP.	
	3 CIRCUIT, 4 WIRE, COMMON NEUTRAL HOME RUN				PHOTO-ELECTRIC CONTROL	AS NOTED	TORK 2000A
	CONDUIT RUN CONCEALED IN WALL OR CEILING				TIME CLOCK	+5'-0"	2.
	CONDUIT RUN CONCEALED IN FLOOR OR GROUND				PUSHBUTTON	+4'-0"	2.
	CONDUIT UP				NON-FUSED DISCONNECT SWITCH	+5'-0"	5.
	CONDUIT DOWN				FUSED DISCONNECT SWITCH	+5'-0"	5.
	CONDUIT STUB LOCATION	CAP CONDUIT			MANUAL STARTER THERMAL OVERLOAD SWITCH WITH PILOT LIGHT	+4'-0"	2.
	CABLE TRAY	AS NOTED			MAGNETIC STARTER	+5'-0"	7.
	CEILING LIGHT FIXTURE	CEILING	1.		MAGNETIC STARTER / DISCONNECT COMBINATION	+5'-0"	
	WALL LIGHT FIXTURE	AS NOTED	1.		VARIABLE FREQUENCY DRIVE	+6'-6"	
	RECESSED DOWNLIGHT FIXTURE	CEILING	1.		PANEL BOARD	TOP AT +6'-0"	
	FLUORESCENT LIGHT FIXTURE	AS NOTED	1		MAIN DISTRIBUTION PANEL		
	FLUORESCENT EGRESS LIGHT FIXTURE	AS NOTED	UNSWITCHED		TELEPHONE TERMINAL BOARD		
	AREA LIGHT POLE AND FIXTURE	CONCRETE BASE	SEE DIAGRAM		BELL	+7'-6"	
	FLOOD OR TRACK FIXTURE	AS NOTED			CHIME	+7'-6"	
	CEILING MOUNTED EXIT LIGHT	CEILING	1.3.8.		FIRE ALARM MANUAL STATION	+4'-0"	2.
	WALL MOUNTED EXIT LIGHT	AS NOTED	1.3.8.		FIRE ALARM SIGNAL HORN/STROBE PROJECTORS	+6'-8"	6.
	SINGLE POLE SWITCH	+4'-0"	2.		FIRE ALARM SIGNAL HORN/STROBE	+6'-8"	6.
	SINGLE POLE SWITCH	+4'-0"	4. 2.		FIRE ALARM SIGNAL SPEAKER/STROBE	+6'-8"	6.
	THREE-WAY SWITCH	+4'-0"	2.		SMOKE DETECTOR	CEILING	
	FOUR-WAY SWITCH	+4'-0"	2.		DUCT SMOKE DETECTOR		MTD. IN DUCT
	KEY OPERATED SWITCH	+4'-0"	2.		HEAT DETECTOR	CEILING	
	SWITCH WITH PILOT LIGHT	+4'-0"	2.		FIRE/SMOKE DAMPER		
	VARIABLE INTENSITY SWITCH	+4'-0"	2.		DOOR HOLDER	AS NOTED	
	TIMER SWITCH	+4'-0"	2.		FLOW SWITCH		
	MOMENTARY CONTACT SWITCH, CENTER POSITION OFF	+4'-0"	2.		TAMPER SWITCH		
	OCCUPANCY SENSOR	CEILING			WATER FLOOD INDICATOR		
	OCCUPANCY SENSOR	+4'-0"	2.		O.S. & Y. VALVE		SEE DIAGRAM
	POWER PACK	CEILING	SEE DIAGRAM, SPEC.		FIRE ALARM RELAY		
	AUTOMATIC RELAY PACK	CEILING	SEE DIAGRAM, SPEC.		FIRE ALARM CONTROL MODULE		
	LOW VOLTAGE TRANSFORMER				FIRE ALARM MONITOR MODULE		
	DUPLEX RECEPTACLE	UPPER OUTLET SWITCH CONTROLLED	+16" OR AS NOTED 9. 11.		FIRE ALARM STROBE	+6'-8"	6.
	SIMPLEX RECEPTACLE		+16" OR AS NOTED 9. 11.		DURESS PUSHBUTTON	+4'-0"	
	DUPLEX RECEPTACLE		+16" OR AS NOTED 9. 11.		SECURITY SYSTEM DOOR SWITCH	DOOR JAMB	
	DUPLEX RECEPTACLE		9.		SECURITY SYSTEM OVERHEAD DOOR SWITCH	CEILING	MOUNT AS PER. MAN
	ELECTRIC WATER COOLER RECEPTACLE		SEE DIAGRAM		MAGNETIC SHEAR LOCK		
	WEATHERPROOF RECEPTACLE	+24" OR AS NOTED	2. 9.		SECURITY SYSTEM KEYED ACCESS SWITCH	+4'-0"	2.
	ISOLATED GROUND RECEPTACLE	+16" OR AS NOTED	9. 11.		INFRARED SENSOR	AS NOTED	
	GROUND FAULT INTERRUPTER DUPLEX RECEPTACLE	+16" OR AS NOTED	9. 11.		SECURITY MOTION DETECTOR		MOUNT AS PER. MAN
	DUPLEX RECEPTACLE EMERGENCY POWER (RED)	+16" OR AS NOTED	9. 11.		GLASS BREAK DETECTOR	CEILING	
	FOURPLEX RECEPTACLE	+16" OR AS NOTED	9. 11.		ELECTRIC DOOR STRIKE		
	FOURPLEX RECEPTACLE EMERGENCY POWER (RED)	+16" OR AS NOTED	9. 11.		ACCESS CONTROL CARD READER	+4'-0"	2.
	FLOOR OUTLET WITH 20A DEVICE	FLOOR			CLOSED CIRCUIT TELEVISION CAMERA	AS NOTED	
	MULTIPLE SERVICE FLOOR BOX	FLOOR			DOOR POSITION INDICATING SWITCH		
	SPECIAL PURPOSE OUTLET	+16" OR AS NOTED	10. WITH CAP. 11.		SOUND SYSTEM SPEAKER	+8'-0" OR AS NOTED	
	CORD DROP		SEE DIAGRAM		INTERCOM SPEAKER	AS NOTED	
	PLUGMOLD	+46" OR AS NOTED			VOLUME CONTROL	+4'-0"	2.
	TELEVISION OUTLET	+16" OR AS NOTED	11.		MICROPHONE OUTLET	+16"	11.
	DATA OUTLET	+16" OR AS NOTED	9. 11.		MICROPHONE FLOOR OUTLET	FLOOR	
	TELEPHONE OUTLET	+16" OR AS NOTED	9. 11.		MICROPHONE CEILING OUTLET	CEILING	
	TELEPHONE/DATA OUTLET	+16" OR AS NOTED	9. 11.		SOUND EQUIPMENT CABINET		CIRCUIT TO 120V
	TELEPHONE OUTLET	FLOOR			ARCHITECTURAL ROOM NUMBER		
	CALL SWITCH	+4'-0"	2.		LIGHT FIXTURE (LETTER DESIGNATES TYPE)		
	CLOCK OUTLET	+7'-6"	8.		EQUIPMENT NUMBER		
	CLOCK/SPEAKER COMBINATION	+7'-6"					

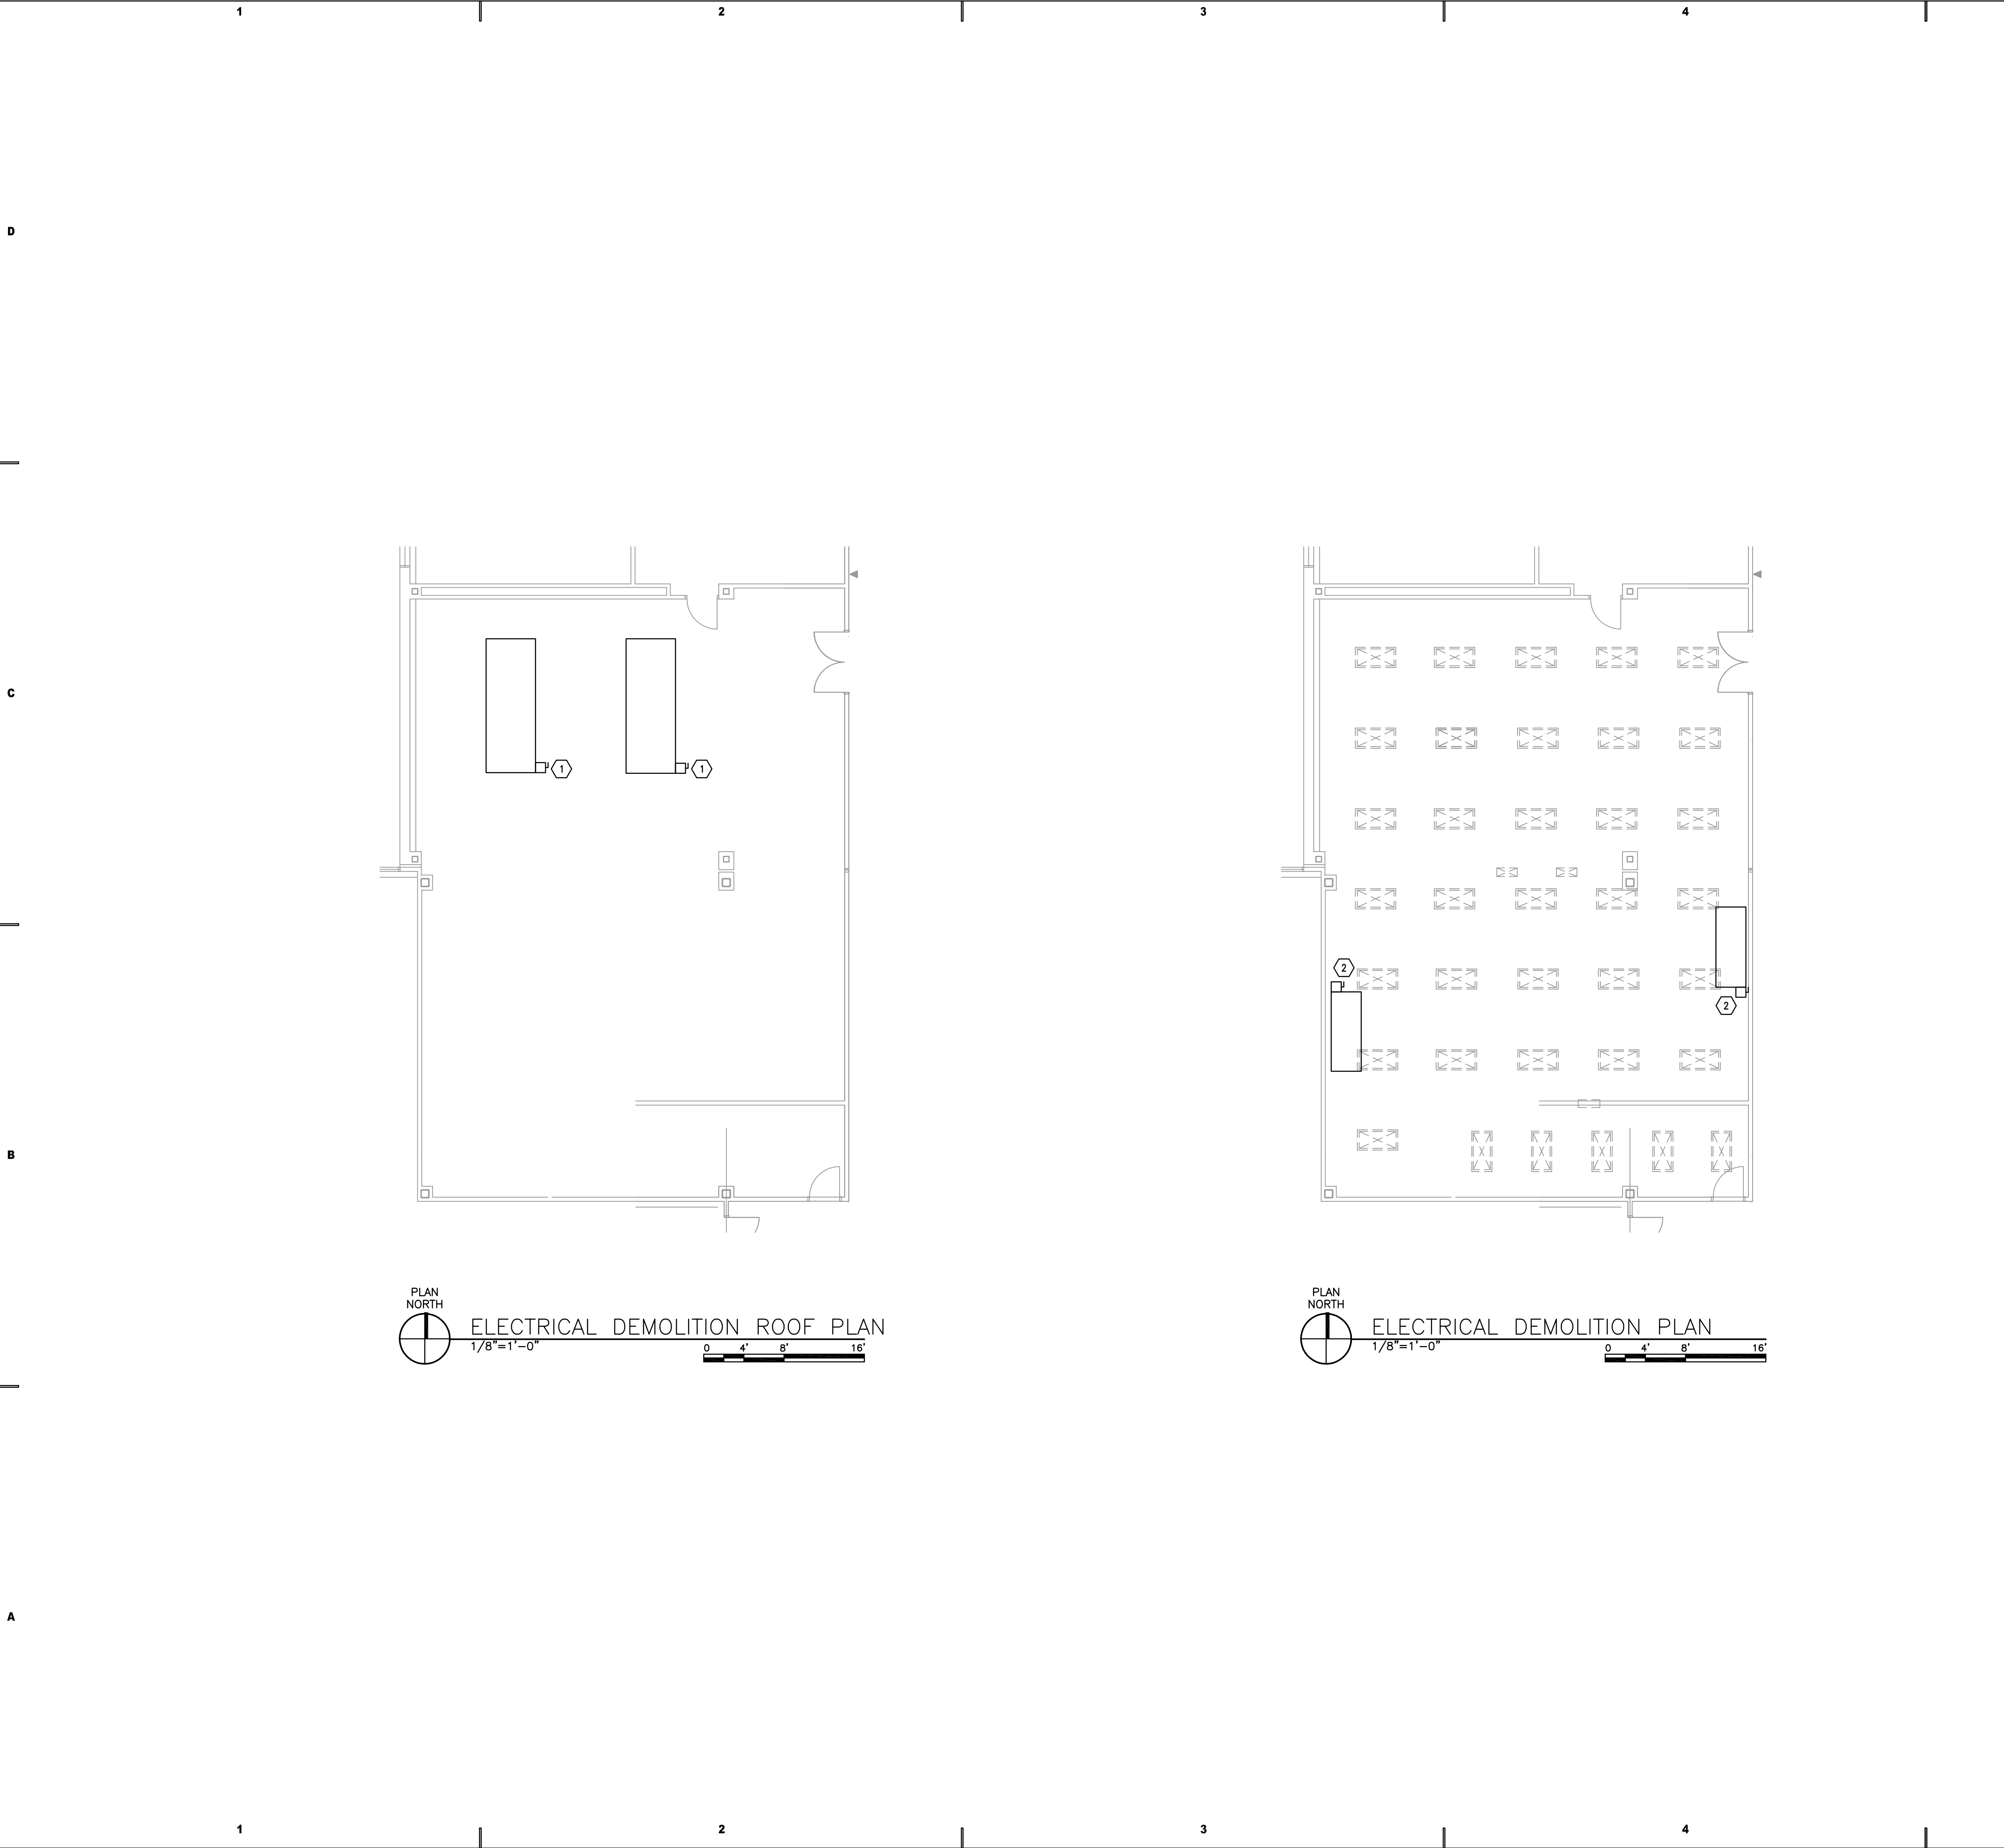

SHEET NOTES

- 1 REMOVE ALL ELECTRICAL EQUIPMENT INCLUDING DISCONNECT AND ALL CONDUIT AND CONDUCTOR BACK TO PANEL 'EL4', FOR BOTH FAN AND PUMP. REMOVE ALL CIRCUIT BREAKERS FROM PANEL 'EL4'.
- 2 REMOVE ALL ELECTRICAL EQUIPMENT, INCLUDING DISCONNECT AND ALL CONDUIT AND CONDUCTOR BACK TO PANEL 'EL4'. REMOVE ASSOCIATED CIRCUIT BREAKERS FROM PANEL 'EL4'. REMOVE BYPASS SWITCH IN ELECTRICAL ROOM ASSOCIATED WITH EQUIPMENT IN PANEL 'EL4'. (SEE SHEET EP101).

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PROJECT NAME & ADDRESS

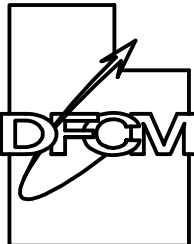**TAX COMMISSION
BLDG. COMP ROOM
AC REPLACEMENT**

DFCM No. 06172310

210 North 1950 West
Salt Lake City, Utah

MARK	DATE	REVISION
1	8/25/06	100% REVIEW SET

PROJECT MANAGER:

JWO

DRAWN BY:

STAFF

CHECKED BY:

MHB

DATE:

08/25/06

BNA JOB NO.:


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SHEET TITLE

**ELECTRICAL
DEMOLITION PLAN**

SHEET NO.


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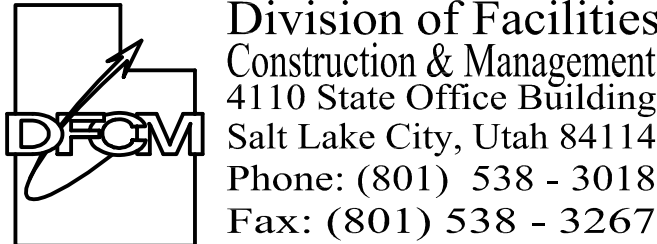
SHEET NOTES

1 BYPASS SWITCH. REMOVE BYPASS SWITCH ASSOCIATED WITH EQUIPMENT IN PANEL 'EL4'. REMOVE ALL CONDUIT AND CONDUCTOR TO PANEL.

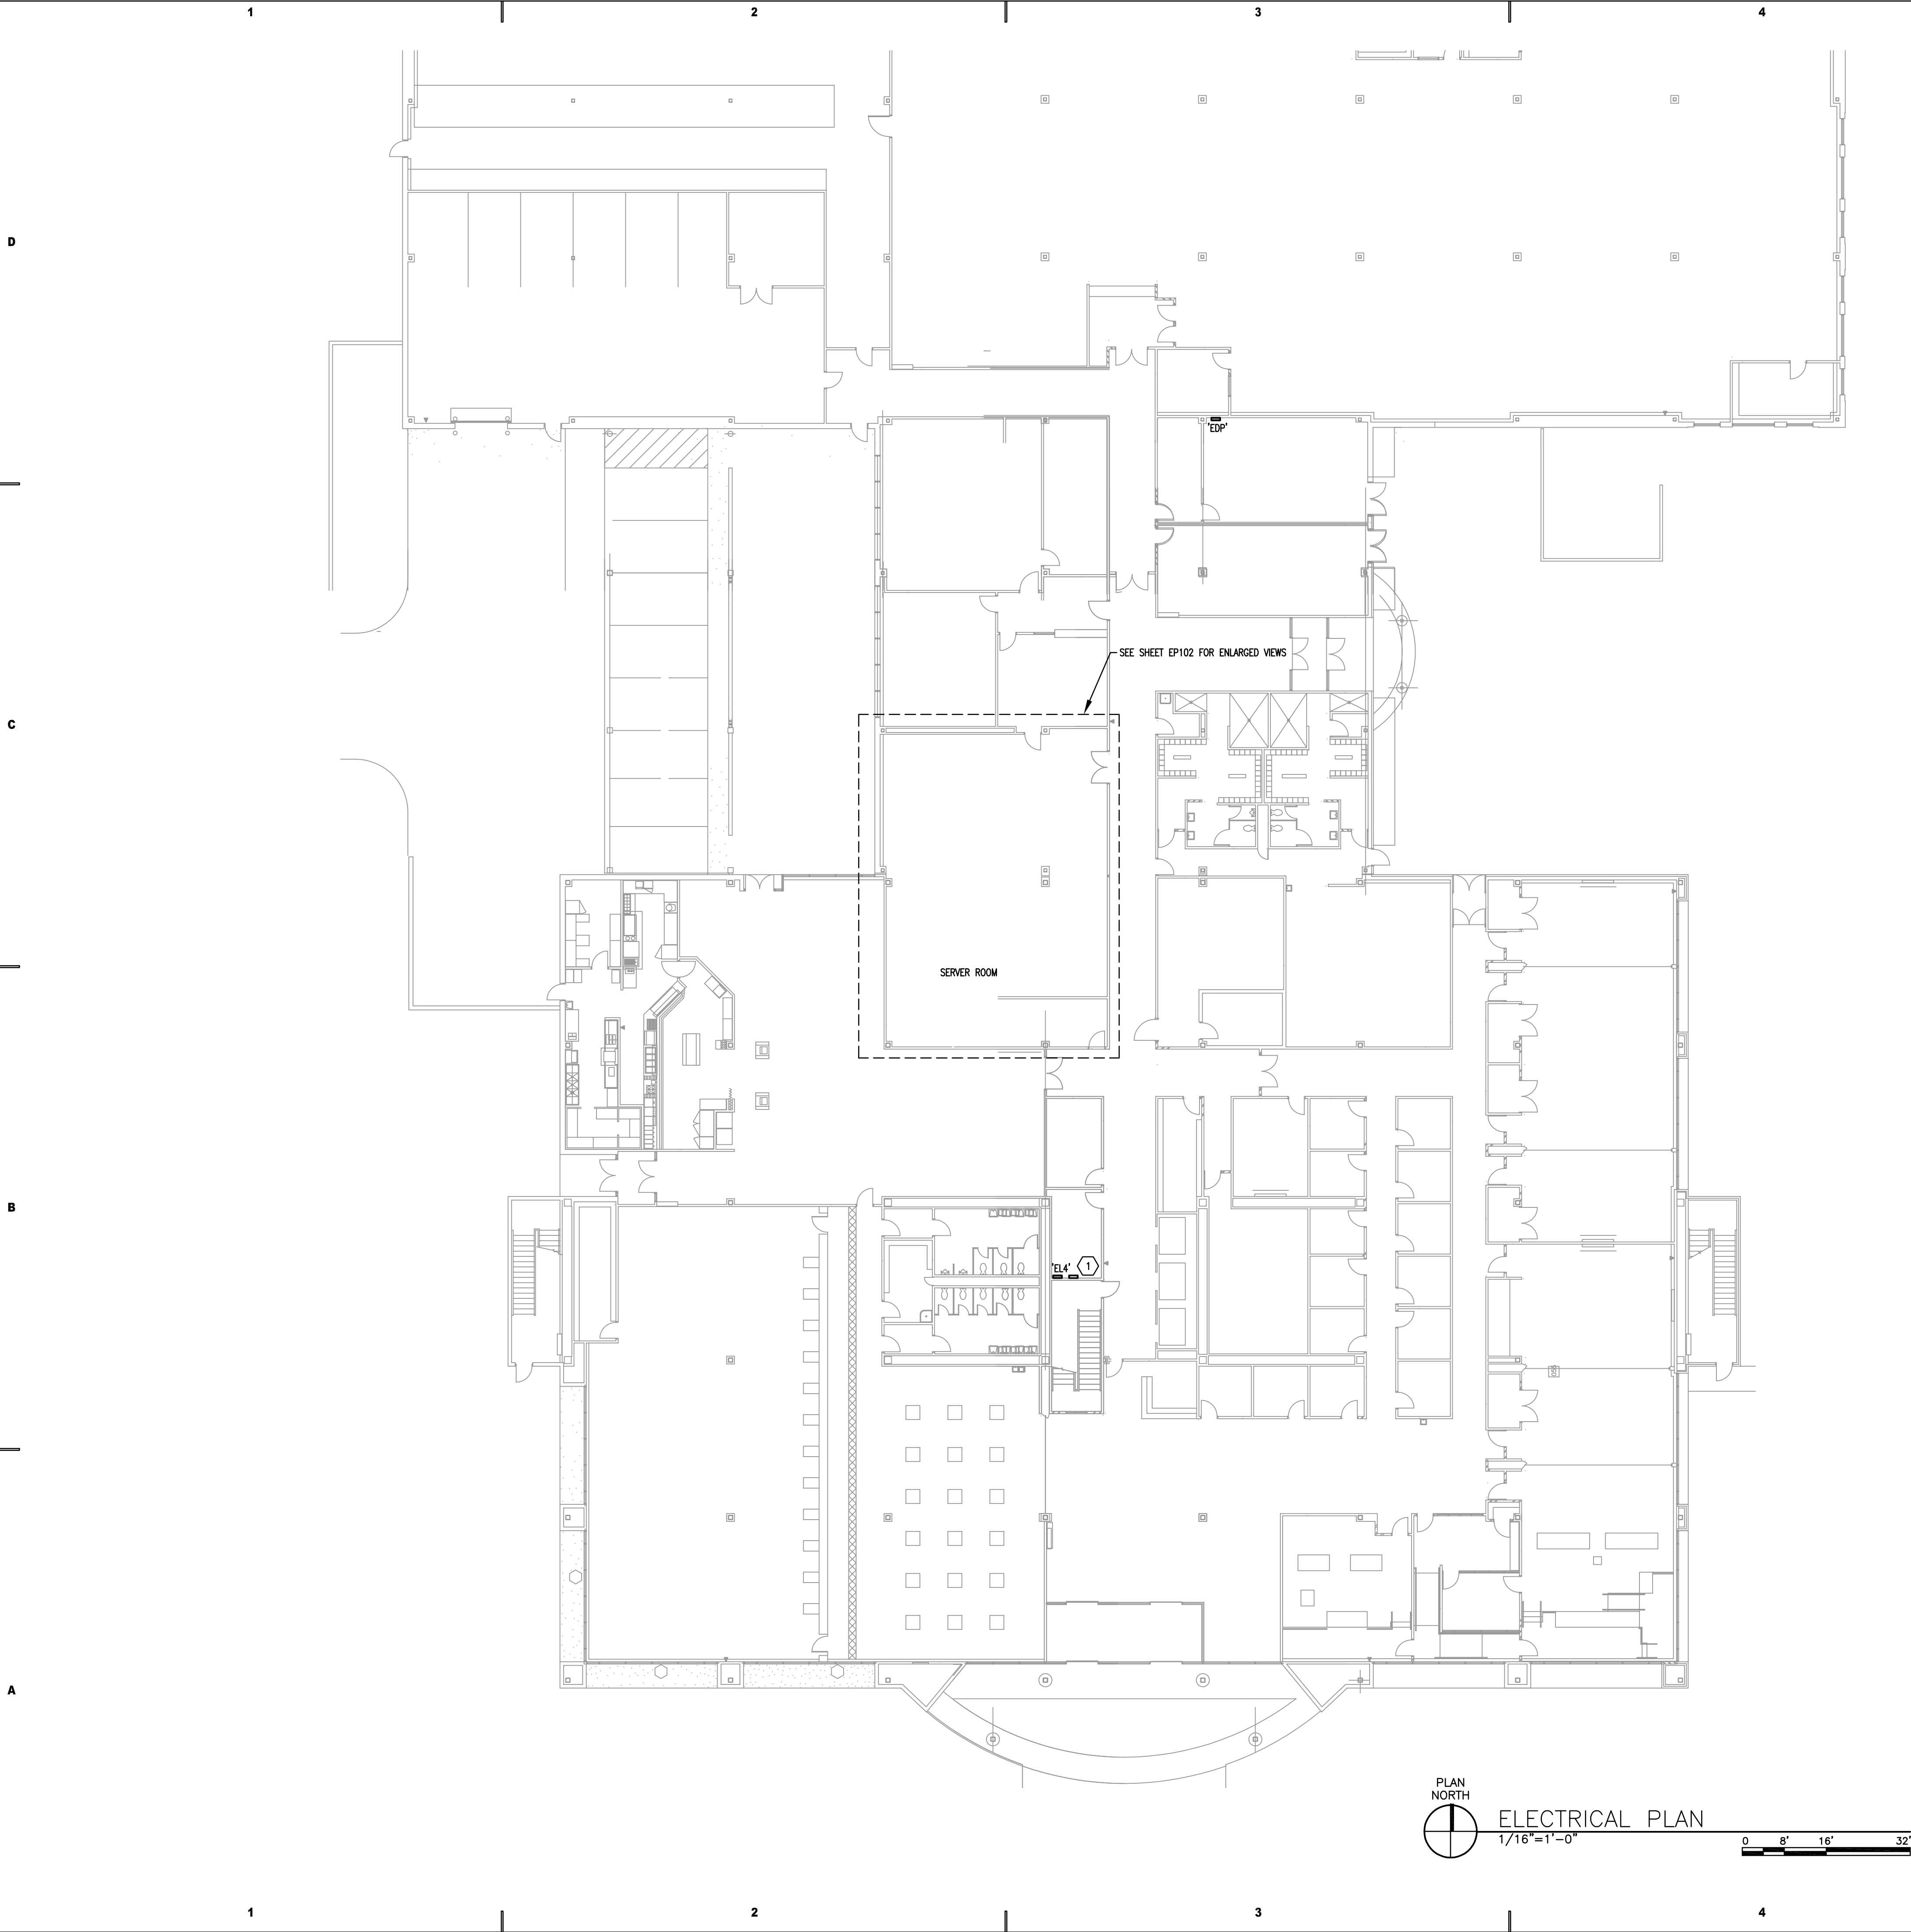KEY PLAN



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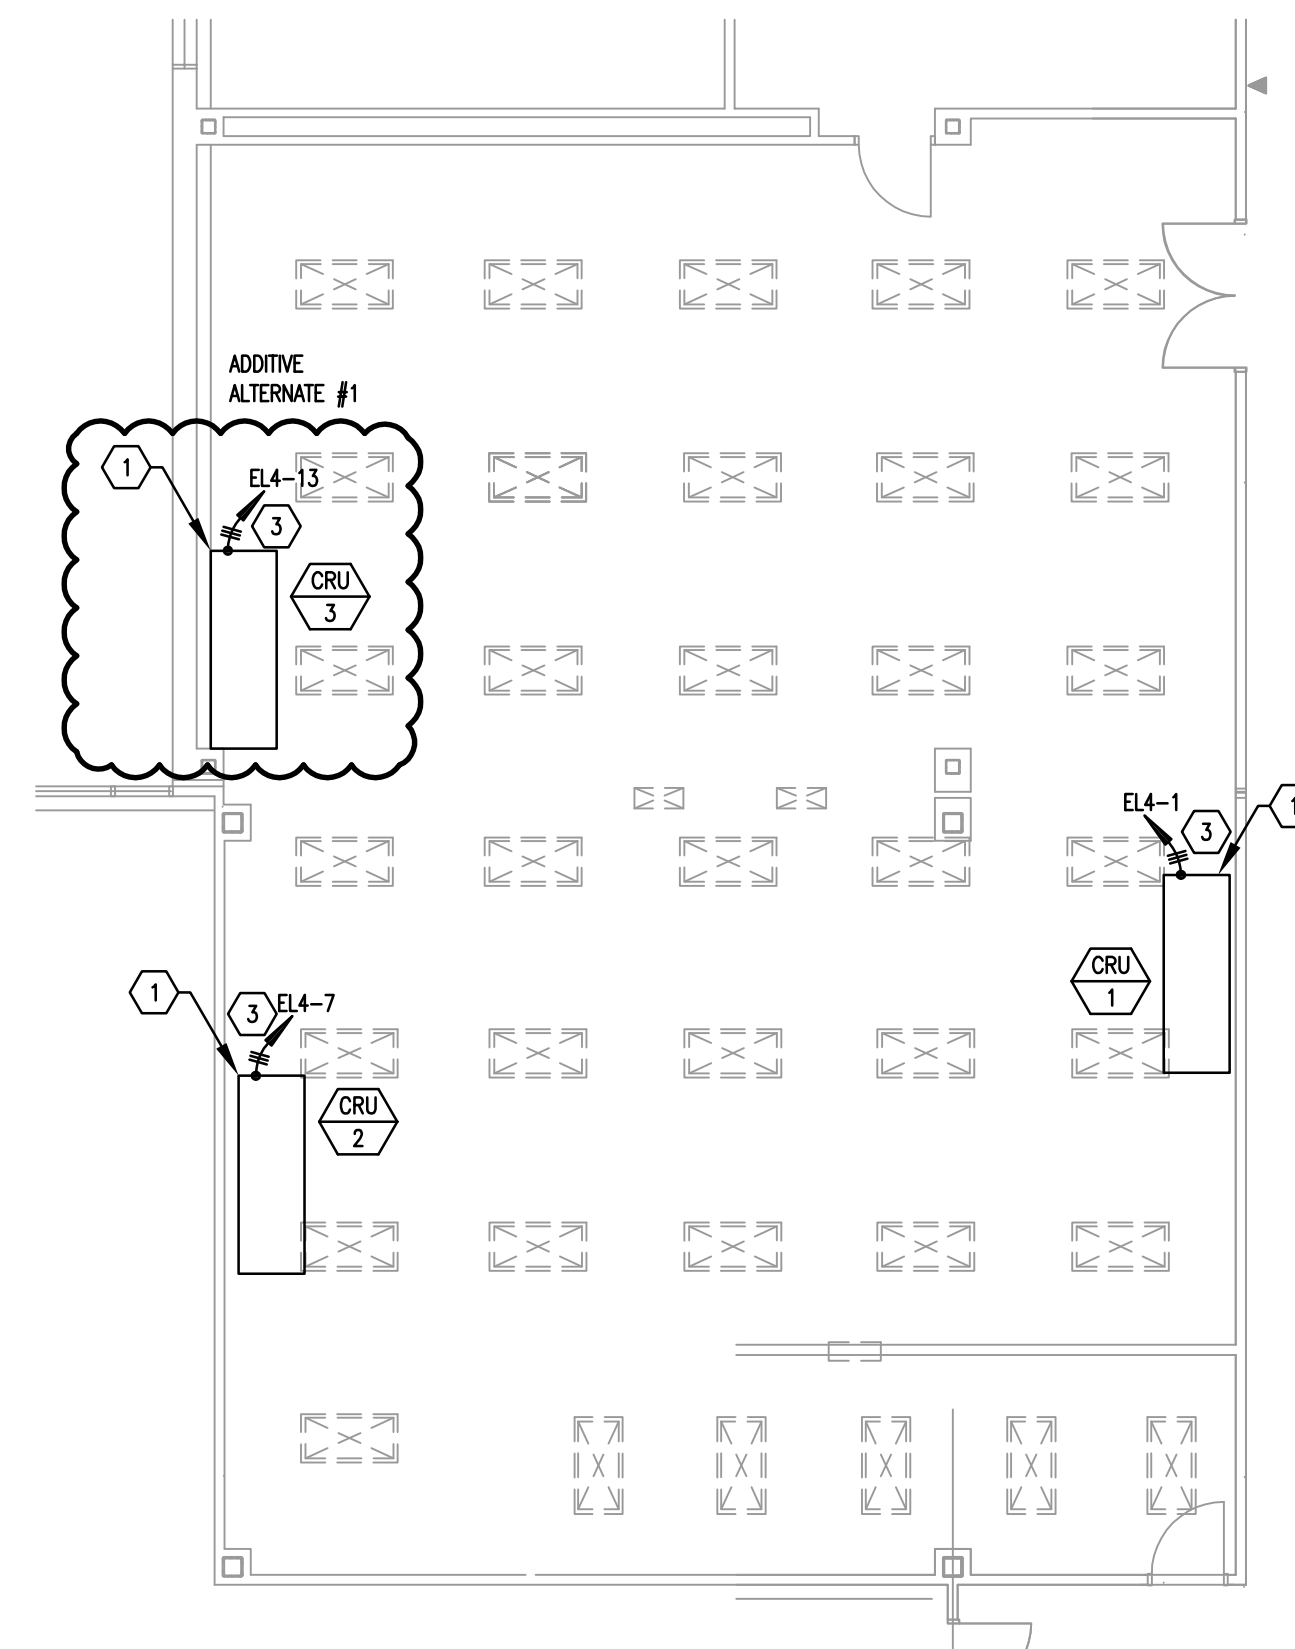
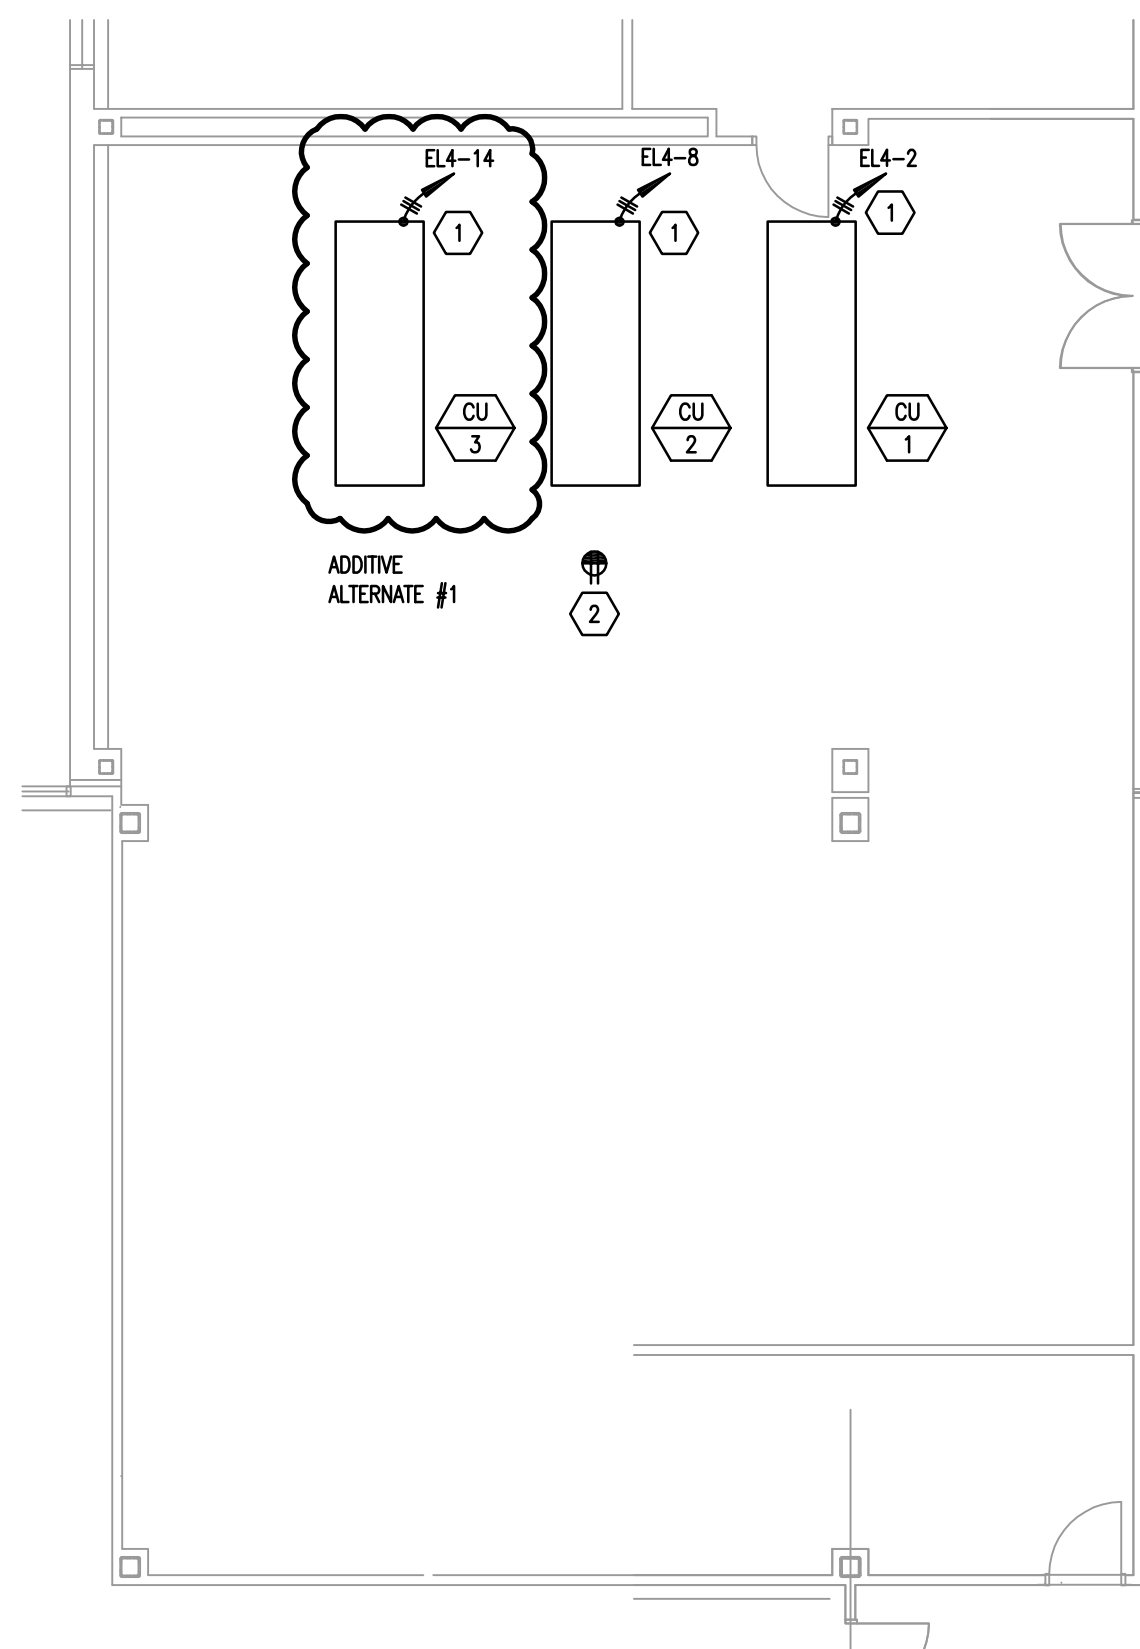
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SHEET TITLE

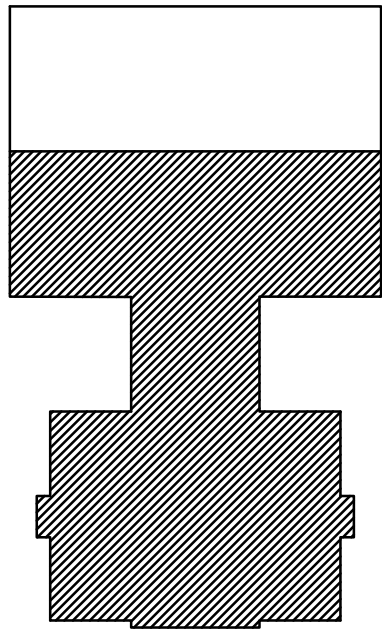**ELECTRICAL POWER
PLAN LEVEL 1**

SHEET NO.


EP101




FOR CONSTRUCTION

SHEET NOTES

- 1 DISCONNECT HAS BEEN INCLUDED IN EQUIPMENT FROM MANUFACTURER.
- 2 PROVIDE GFCI RECEPTACLE AS PER NEC SECTION 210.
- 3 CONTROLS MUST BE PROGRAMMED TO ENSURE THAT ONLY 1 CRU UNIT STARTS AT A TIME WITH A MAXIMUM OF 2 UNITS BEING ON SIMULTANEOUSLY. ELECTRICAL CONTRACTOR TO INSTALL 3/4" CONDUIT AND WIRING FROM INDOOR UNITS TO OUTDOOR UNITS.

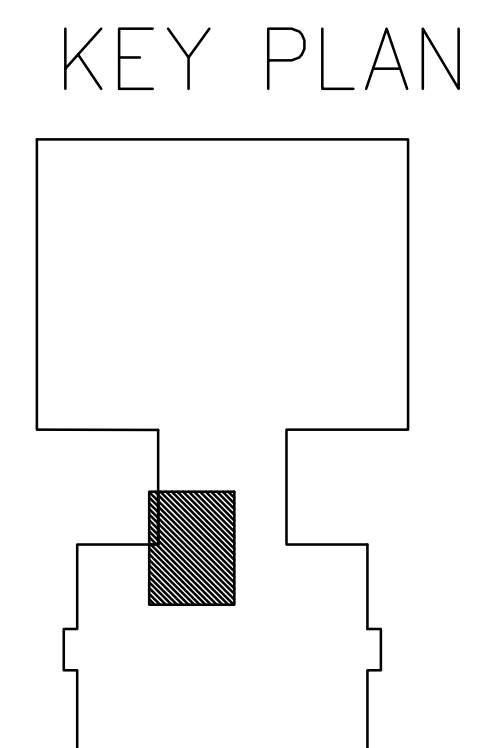

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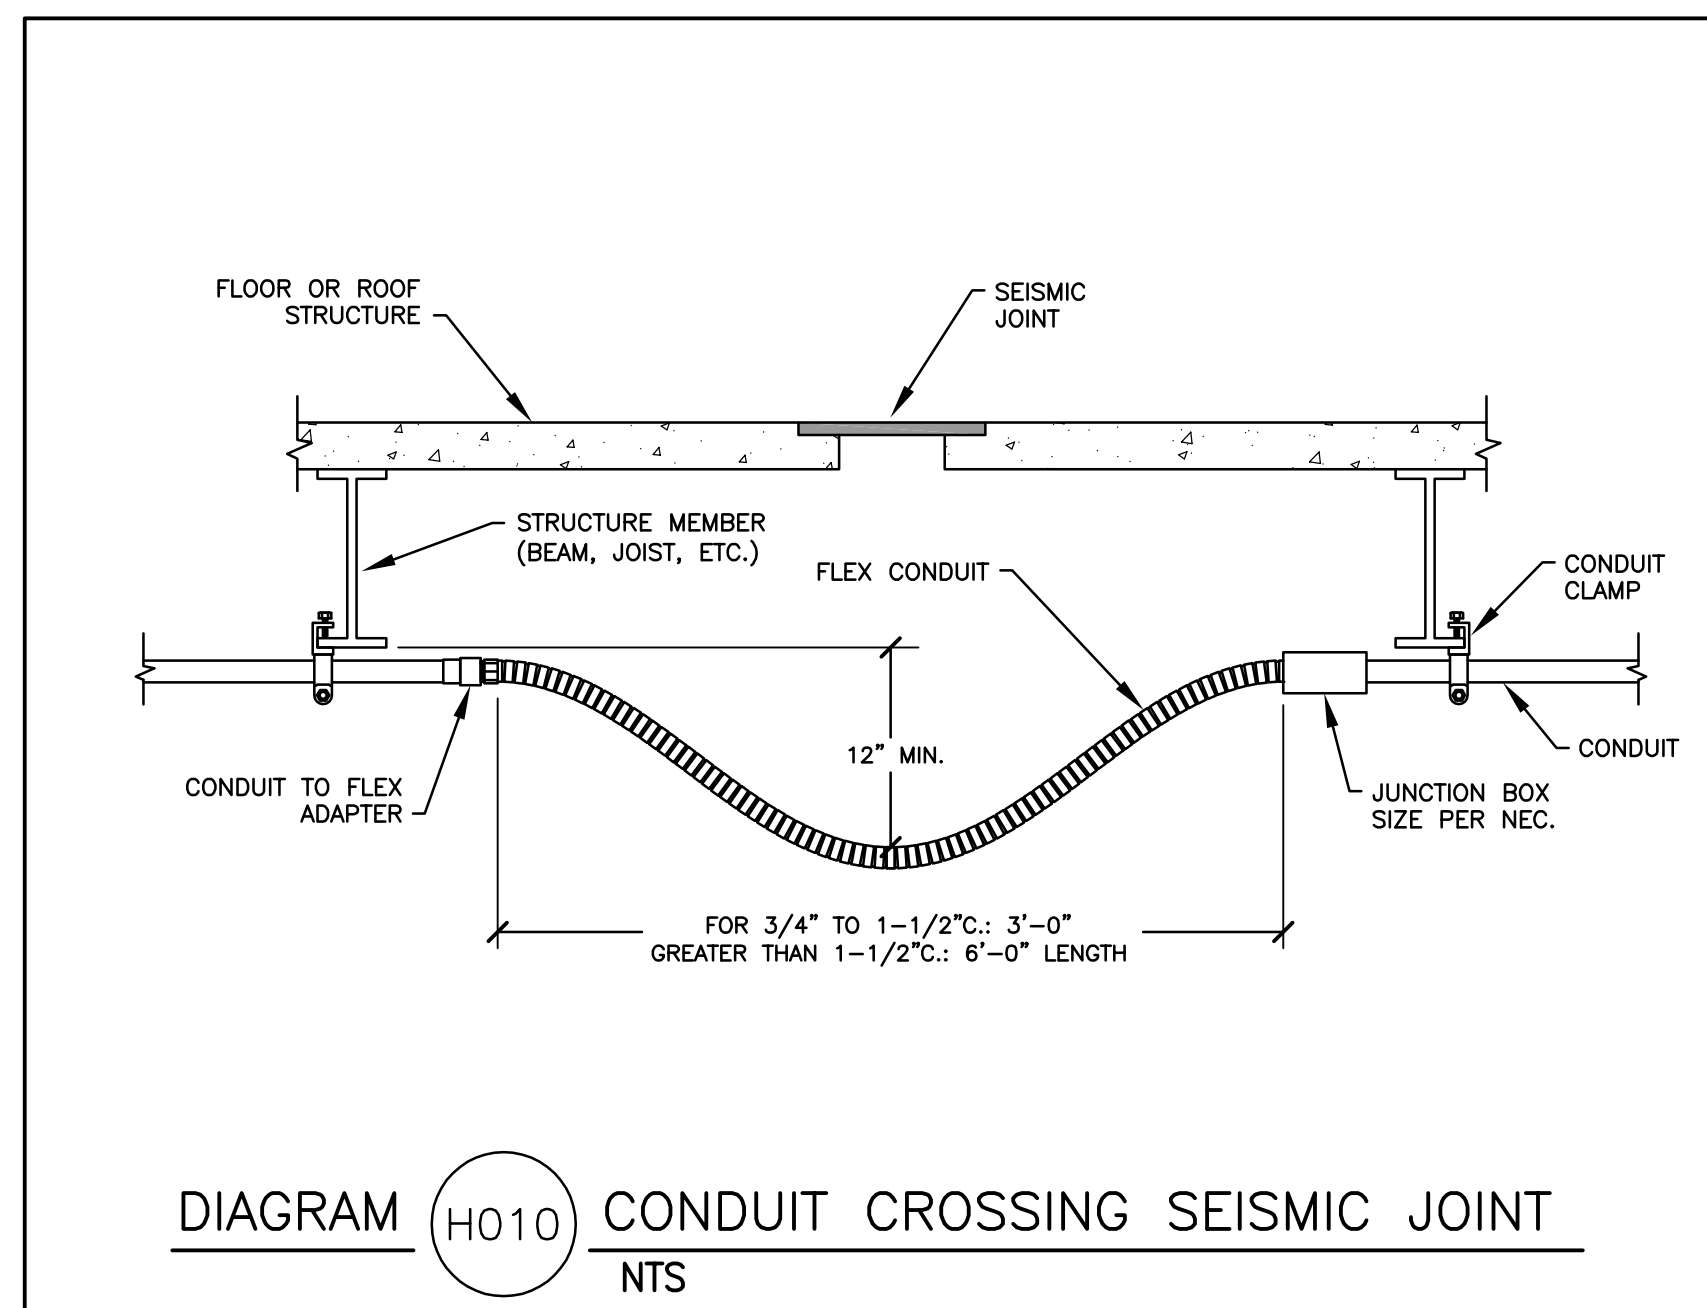
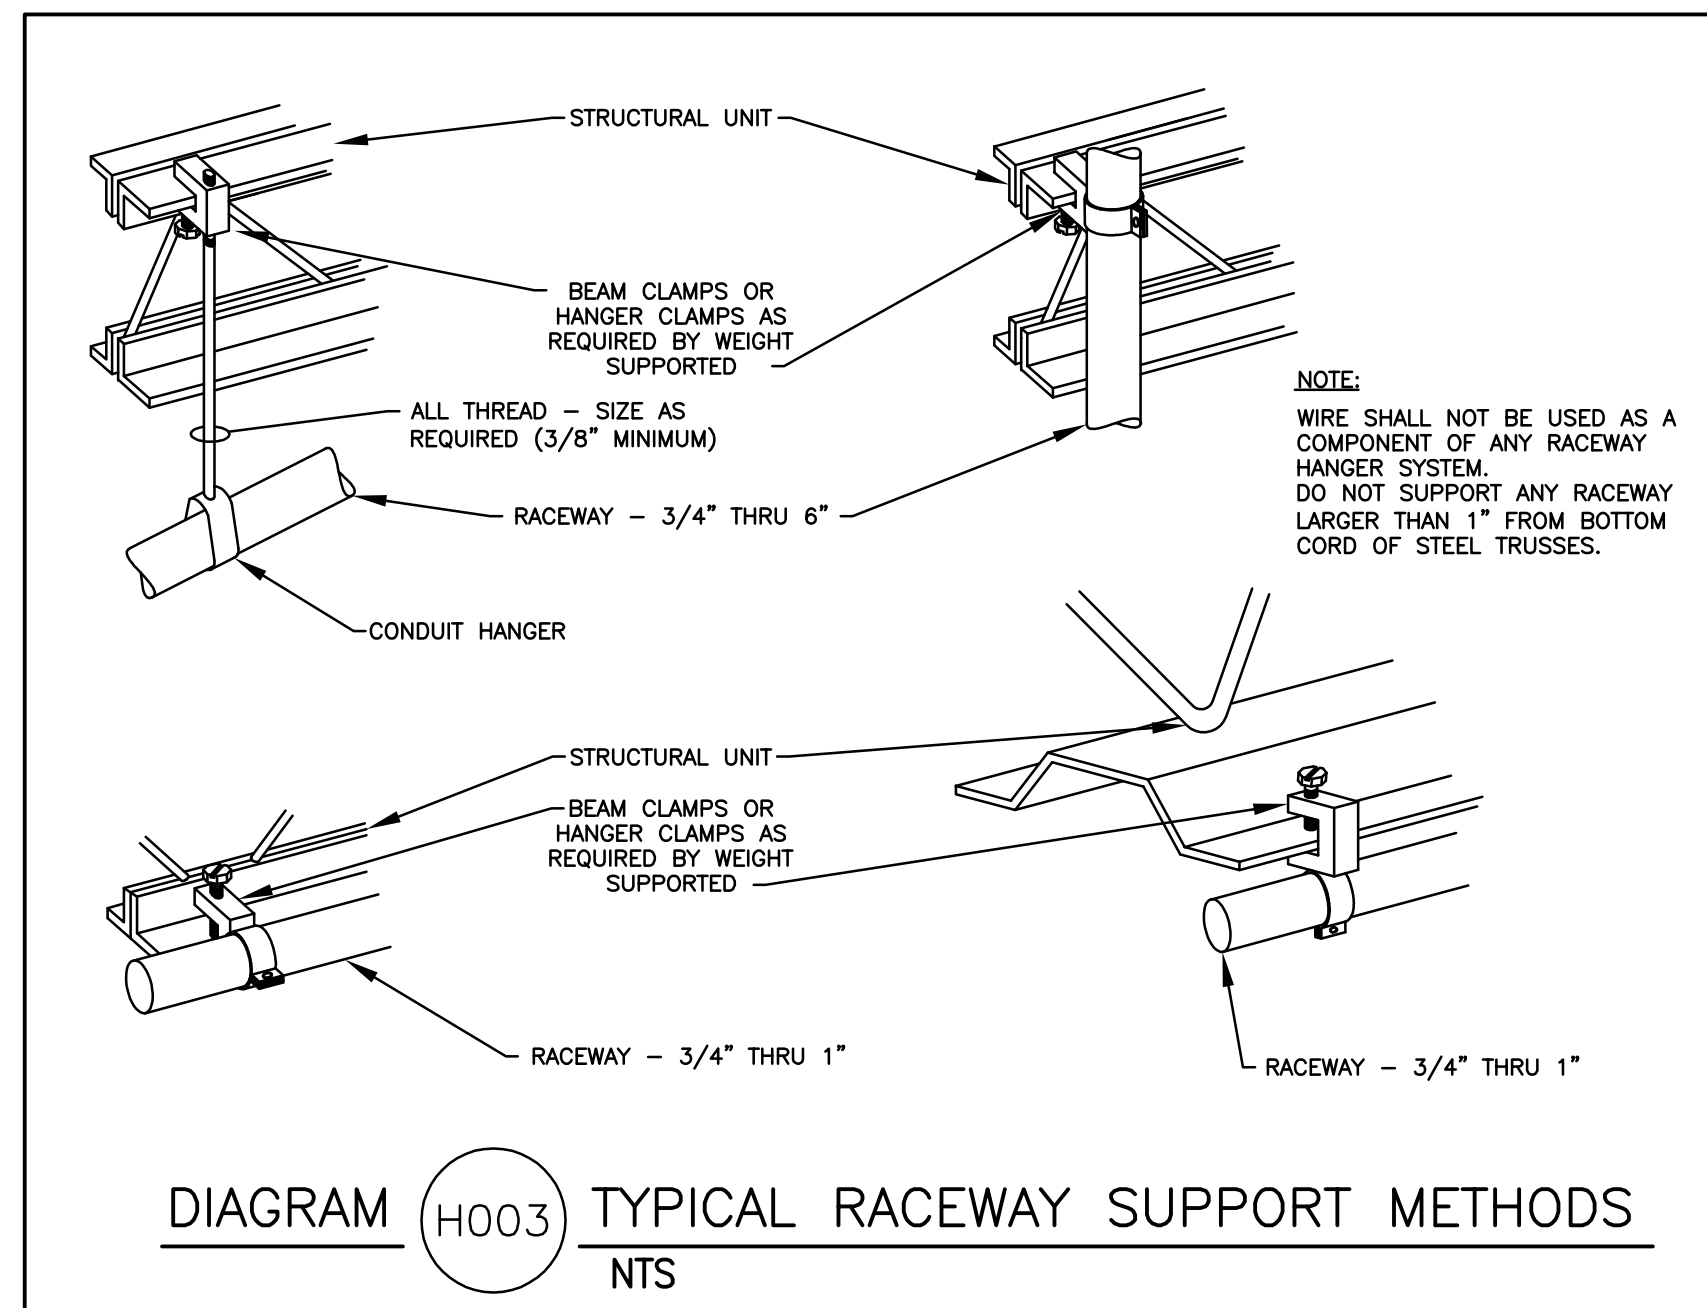
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SHEET TITLE

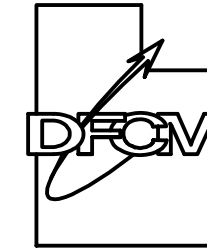ENLARGED ELECTRICAL PLAN


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0. **EP102**



SHEET NOTES

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06/29/00
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SHEET TITLE

ELECTRIC

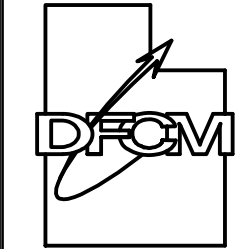ELECTRICAL DETAILS

SHEET NO.

EX101